APPENDIX E

Engineering Report prepared by Westera Partners





Engineering Services Report

Proposed Retirement Living Development

99 Hogarth Drive, Bohle Plains

For: Ruby Developments Pty Ltd

2 August 2024

Ref: S24-020



CERTIFIED QUALITY ASSURANCE - ISO AS/NZS 9001, 4801 & 14001

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DOCUMENT INFORMATION

Project Name: 99 Hogarth Drive, Bohle Plains

Westera Partners Ref: S24-020

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Certified for Issue by:

Jared Hill RPEQ 19891

2 August 2024

Document Control:

Revision	Author	Approved for Issue	Date
Rev A	P. Baxter	J. Hill RPEQ 19891	2/08/2024

This report has been prepared for Ruby Developments Pty Ltd for the purpose of accompanying a development application to Townsville City Council. This report must only be used by Ruby Developments Pty Ltd for this purpose and must not be used or relied upon by any other person for any other purpose.

The assessment, conclusions or recommendations in this report are based on conditions encountered and information received at the time of preparing the report and may not be relied upon as site conditions or operations vary over time.



CONTENTS

1	INTRODUCTION	1
2	SITE DESCRIPTION	1
2.1	Location and Land Use	1
3	EXTERNAL ROADWORKS	2
4	STORMWATER DISCHARGE	2
5	SEWER RETICULATION	2
6	WATER RETICULATION	3
7	FLOODING	3
8	EARTHWORKS	3
9	GAS, ELECTRICITY & COMMUNICATIONS	3
10	CONCLUSION	3
11	APPENDICES	A-1
Append	lix A – Townsville City Council Flood Overlay	A-1
Append	lix B – Before You Dig Information	B-1
Append	lix C – Engineering Plans	C-1
Append	lix D – Survey and Architectural Drawing	D-1
Append	lix E – As-Constructed Information	E-1
List of I	Figures	
Fi	igure 1 – Indicative development footprint (Nearmaps, 2024)	1



INTRODUCTION

Westera Partners Pty Ltd has been commissioned by Ruby Developments Pty Ltd to prepare an Engineering Services Report to accompany a development application for a proposed retirement living development.

The development application involves the construction of 292 retirement living dwellings, including facilities, parking and landscaping. Access to the site is to be provided from Hogarth Drive.

This report documents how the site will be serviced in accordance with Townsville City Council requirements.

2 SITE DESCRIPTION

2.1 Location and Land Use

The proposed development site is located at 99 Hogarth Drive, Bohle Plains also known as Lot Plan 1002 on SP340654. The site area is approximately 13.67Ha, and the development proposal will occur over approximately 13.01Ha. The site is primarily vacant and covered by light cover bushland and grass. The northern portion of the site currently falls towards a mapped waterway close to the northern boundary which ultimately discharges to Three Mile Creek, and the southern portion falls towards the southern boundary via multiple mapped waterways located within the site, which then ultimately discharge towards existing infrastructure on Hogarth Dr.

The proposed development site is bound by Three Mile Creek to the north, urban residential development to the east and south, and The Ring Road to the west. Refer to Figure 1 for an indicative site location.



Figure 1 - Indicative development footprint (Nearmaps, 2024)



3 EXTERNAL ROADWORKS

The site will gain entry from Hogarth Drive. The main site entry will be from the northern round about (not yet constructed) with a secondary emergency exit to the southern round about. Minimal external roadworks will be required, limited to what will be required to tie in with the existing road network to provide the site access points.

4 STORMWATER DISCHARGE

Stormwater drainage for the proposed development shall ensure no adverse impact on upstream, downstream or adjoining properties. The proposed lawful points of discharge for the development shall be the existing mapped waterways. The southern catchment of the proposed development is to discharge to an existing mapped waterway located within the adjoining easement (EMT H RP739629) which then flows beneath Hogarth Dr via an existing culvert. The northern portion of the site and RV compound area are proposed to discharge to an existing mapped waterway which then connects to Three Mile Creek. New on-site stormwater infrastructure shall be constructed to direct stormwater to the lawful point of discharge to ensure no adverse impacts on adjacent properties.

The overland flow analysis prepared by Engeny has determined no adverse impacts off site as a result of the increase in impervious area fraction from the development. Stormwater detention is therefore not considered to be required. Refer to separate overland flow investigation for further information.

The proposed development is required to meet the Queensland Government's State Planning Policy (July 2017) and TCC requirements as the site exceeds the 2,500m² minimum site area. To ensure compliance stormwater treatment is proposed to be managed on-site through primary treatment from filter basket inserts into the field inlets on the road and tertiary treatment from ATLAN filter cartridges in the treatment tanks. MUSIC modelling has been undertaken to demonstrate runoff from the development site achieves the water quality pollution load reduction targets of the TCC & State Planning Policy

Refer to detailed Stormwater Report prepared by Westera Partners Pty Ltd and engineering drawings contained within Appendix C for further information on proposed stormwater works for the development.

All stormwater works shall be in accordance with Townsville City Council's standards and specifications.

5 SEWER RETICULATION

The current site survey and as-constructed information (Appendix E) provided indicate existing sewer infrastructure throughout the site, with a sewer reticulation main located in the northern portion of the site and an extension of the sewer network installed into the proposed development site near the southern boundary. It is to be noted that Townsville mapping does not reflect the current arrangement of these services, with all sewer services within the proposed development on the mapping marked as future gravity mains in different locations, indicating mapping has yet to be updated. For the proposed development, two sewer connection points will be utilised to service the site. The southern portion of the site is to be serviced by a 150mm property connection connected to the sewer extension located toward the southern boundary, which then connects to existing sewer mains. For the northern portion of the site, a 150mm property connection will be installed from the existing sewer main which then connects to an existing 225mm sewer main.

All sewer reticulation works shall be in accordance with Townsville City Council standards and specifications and the CTM code.



WATER RETICULATION

As-constructed data provided also indicated that there is an existing 300mm trunk main water located within the verge of Hogarth Drive, which then has a 150mm service extending towards the proposed development site, which is capped at the property boundary. For the proposed development, this existing water service will be utilised, with the development service size to be finalised at the detailed design phase of the project to suit the development's hydraulic demand. Refer to Appendix B for further information regarding the proposed water works.

All water reticulation works shall be in accordance with Townsville City Council standards and specifications and the CTMC ode.

7 FLOODING

The proposed development site is impacted by Townsville's flood overlay mapping. The overlay identifies various defined flood levels throughout. To ensure flood immunity throughout the site, the building floor levels are set to ensure a 300mm freeboard is achieved in line with the TCC flood requirements. Refer to the separate flood report completed by Engeny for further information.

8 EARTHWORKS

Earthworks operations for the proposed development will involve earthworks over the entire development footprint to establish building sites for future homes, achieve necessary flood immunity and manage stormwater appropriately. An acid sulphate soil investigation is not considered necessary as excavation will not extend below 5.0m AHD.

All earthworks shall be in accordance with Townsville City Council standards and specifications.

9 GAS, ELECTRICITY & COMMUNICATIONS

There is no gas main within close proximity to the proposed development.

Telstra and NBN services are located with Hogarth Drive.

There is below ground electrical infrastructure within Hogarth Drive. Refer to Appendix D & E for further information.

10 CONCLUSION

This engineering services report establishes that the proposed development can be adequately serviced by the existing sewer, water, and other infrastructure services surrounding the site.

The proposed lawful point of discharge for the development shall be the existing mapped waterways, with the southern portion of the site discharging towards existing culverts and the northern portion of the site to ultimately discharge to Three Mile Creek. Stormwater detention is not required for the site. The site is required to meet the water quality requirements as the site exceeds the 2,500m² minimum site area. To ensure compliance stormwater treatment is proposed through primary treatment from filter basket inserts into the field inlets and tertiary treatment from ATLAN filter cartridges. MUSIC modelling has been undertaken to demonstrate the site achieve the pollution load reduction targets.

The existing sewer infrastructure within the site will be utilised to service the proposed development. The southern portion of the site will connect to the existing sewer main extension via a 150mm property



connection, whilst for the northern portion of the site, a 150mm property connection will be installed from the existing sewer main.

A new water service shall be constructed to service the site from the existing water service which is connected to the trunk main located within Hogarth Dr and centrally to the proposed development. The development service size will be finalised at the detailed design phase of the project to suit the hydraulic demand.

The site is impacted by flooding events, and minimum levels have been set throughout the proposed development to ensure building immunity from flooding and compliance with TCC requirements.


Earthworks shall be undertaken across the development site to establish building pads, achieve required levels of shared access roads, and appropriately manage stormwater.

Final details regarding stormwater, sewer, water and other services can be addressed during the detail design stage.



11 APPENDICES

Appendix A - Townsville City Council Flood Overlay

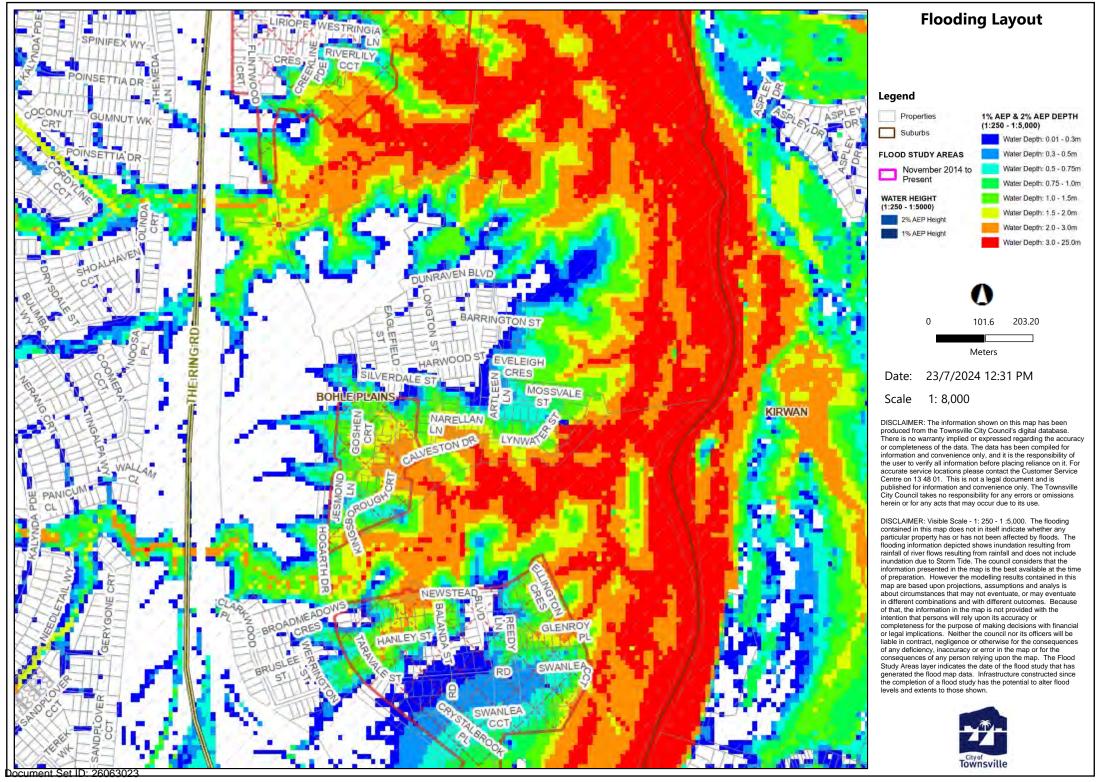

Version: 1, Version Date: 10/09/2024



Appendix B - Before You Dig Information

99 Hogarth Drive



Review responses online >



Received 6 of 6 responses All responses received

99 Hogarth Drive, Bohle Plains QLD 4817

Job dates 17/04/2024 → 17/04/2024

These plans expire on 15 May 2024

Lodged by Edoardo Baroni

Authority		Page
☑ BYDA Confirmation		2
APA Group Gas Networks (70715)	Received	4
III Dept Of Defence	Received	13
Ergon QLD	Received	24
III NBN Co Qld	Received	50
III Telstra QLD Regional	Received	70
Townsville City Council	Received	80

Enquirer ID



Contact Details

Contact Contact number Company

Edoardo Baroni (07) 5391 3777 Westera Partners

a Partners 3538054

Address

Unit 27 13 Norval Court Maroochydore QLD 4558

Job Site and Enquiry Details

edoardob@westerapartners.com.au

WARNING: The map below only displays the location of the proposed job site and does not display any asset owners' pipe or cables. The area highlighted has been used only to identify the participating asset owners, who will send information to you directly.

Enquiry date	Start date	End date	On behalf of	Job purpose	Locations	Onsite activities
17/04/2024	17/04/2024	17/04/2024	Other Westera	Excavation	Private	Mechanical Excavation
			Partners			



Check that the location of the job site is correct. If not, you must submit a new enquiry.

If the scope of works change or plan validity dates expire, you must submit a new enquiry.

Do NOT dig without plans. Safe excavation is your responsibility. If you don't understand the plans or how to proceed safely, please contact the relevant asset owners.

User Reference 99 Hogarth Drive Address
99 Hogarth Drive
Bohle Plains QLD 4817

Notes/description

-

Your Responsibility and Duty of Care

- Lodging an enquiry does not authorise project commencement. Before starting work, you must obtain all necessary information from all affected asset owners.
- If you don't receive plans within 2 business days, contact the asset owner & quote their sequence number.
- Always follow the 5Ps of Safe Excavation (page 2), and locate assets before commencing work.
- Ensure you comply with State legislative requirements for Duty of Care and safe digging.
- If you damage an underground asset, you MUST advise the asset owner immediately.
- By using the BYDA service, you agree to the Privacy Policy and Term of Use.
- For more information on safe digging practices, visit www.byda.com.au

Asset Owner Details

Below is a list of asset owners with underground infrastructure in and around your job site. It is your responsibility to identify the presence of these assets. Plans issued by Members are indicative only unless specified otherwise. Note: not all asset owners are registered with BYDA. You must contact asset owners not listed here directly.

Referral ID (Seq. no)	Authority Name	Phone	Status
238059701	APA Group Gas Networks (70715)	1800 085 628	NOTIFIED
238059700	Dept Of Defence	0472 724 745	NOTIFIED
238059704	Ergon QLD	13 10 46	NOTIFIED
238059699	NBN Co Qld	1800 687 626	NOTIFIED
238059702 Telstra QLD Regional		1800 653 935	NOTIFIED
238059703 Townsville City Council		1300 878 001	NOTIFIED

END OF UTILITIES LIST

Version: 1, Version Date: 10/09/2024



Plan

Plan your job. Use the BYDA service at least one day before your job is due to begin, and ensure you have the correct plans and information required to carry out a safe project.



Prepare

Prepare by communicating with asset owners if you need assistance. Look for clues onsite. Engage a skilled Locator.



Pothole

Potholing is physically sighting the asset by hand digging or hydro vacuum extraction.



Protect


Protecting and supporting the exposed infrastructure is the responsibility of the excavator. Always erect safety barriers in areas of risk and enforce exclusion zones.



Proceed

Only proceed with your excavation work after planning, preparing, potholing (unless prohibited), and having protective measures in place.

Engage a skilled Locator

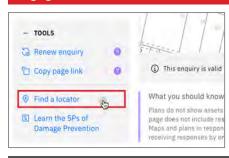

When you lodge an enquiry you will see skilled Locators to contact

Visit the Certified Locator website directly and search for a locator near you

dbydlocator.com/certified-locating-organisation

Book a FREE BYDA Session



BYDA offers two different sessions to suit you and your organisation's needs. The free sessions are offered in two different formats - online and face-to-face:

- 1. **Awareness Session:** Understand the role of BYDA, safe excavation practices, complying with asset-owner instructions, and the consequences of damages. Learn how to mitigate and avoid potential damage and harm and ensure a safe work environment.
- 2. **Plan Reading Session:** Develop the skills to interpret asset owners' plans, legends, and symbols effectively. Understand the complexities of plan interpretation to ensure smooth project execution.

To book a session, visit:

byda.com.au/contact/education-awareness-enquiry-form/


BOOK NOW


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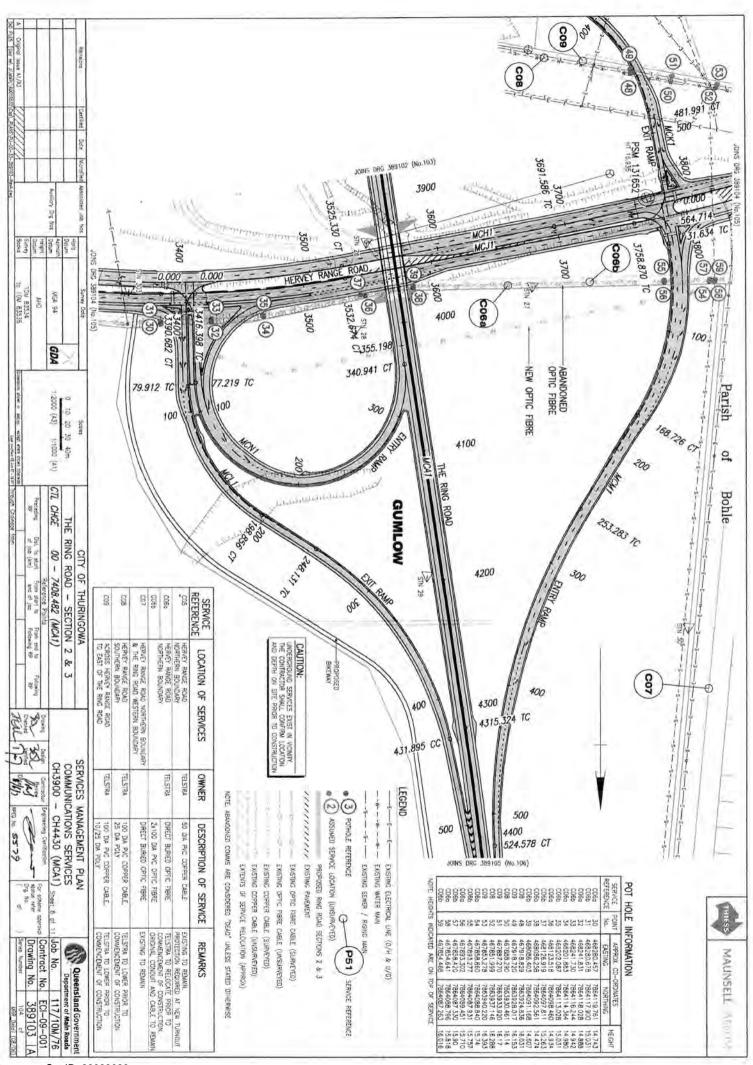






Site Address Name	99 Hogarth Drive Bohle Plains 4817 Edoardo Baroni		Sequence No	238059701	
Colorine Dry of Bullimba Way Avanta Ct. Sand a Bulling Ct. Sand a Bull	Cr Kemrediebuilt Sales Ct Cr Colinda Ct	e Ring Rd Mile Creek	, and the GIS User Commun	Swan! Citystalbrook by	
Scale 1: 60	000	A 2	Enquiry Are	ea Map Key Area	




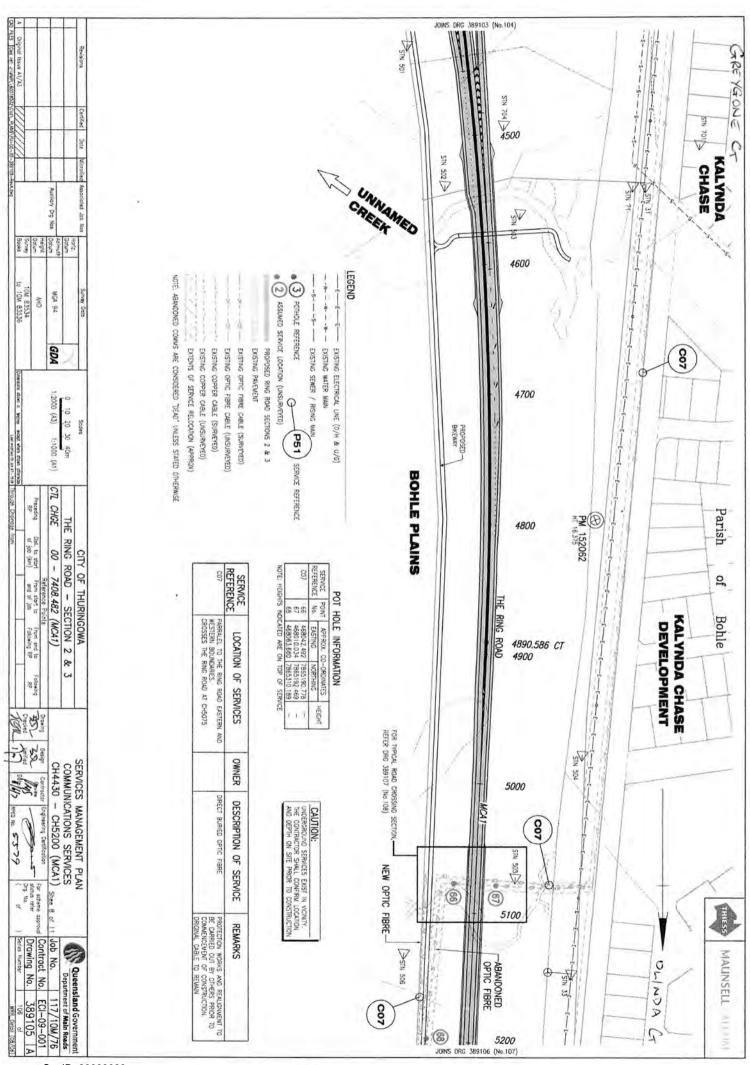


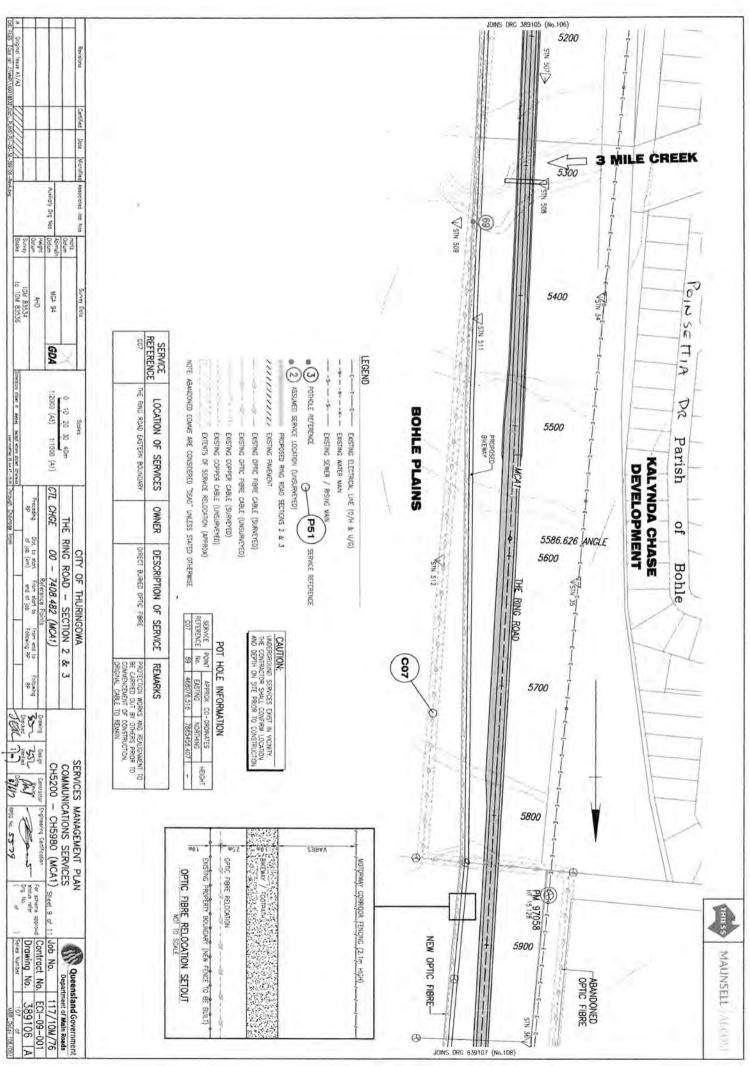


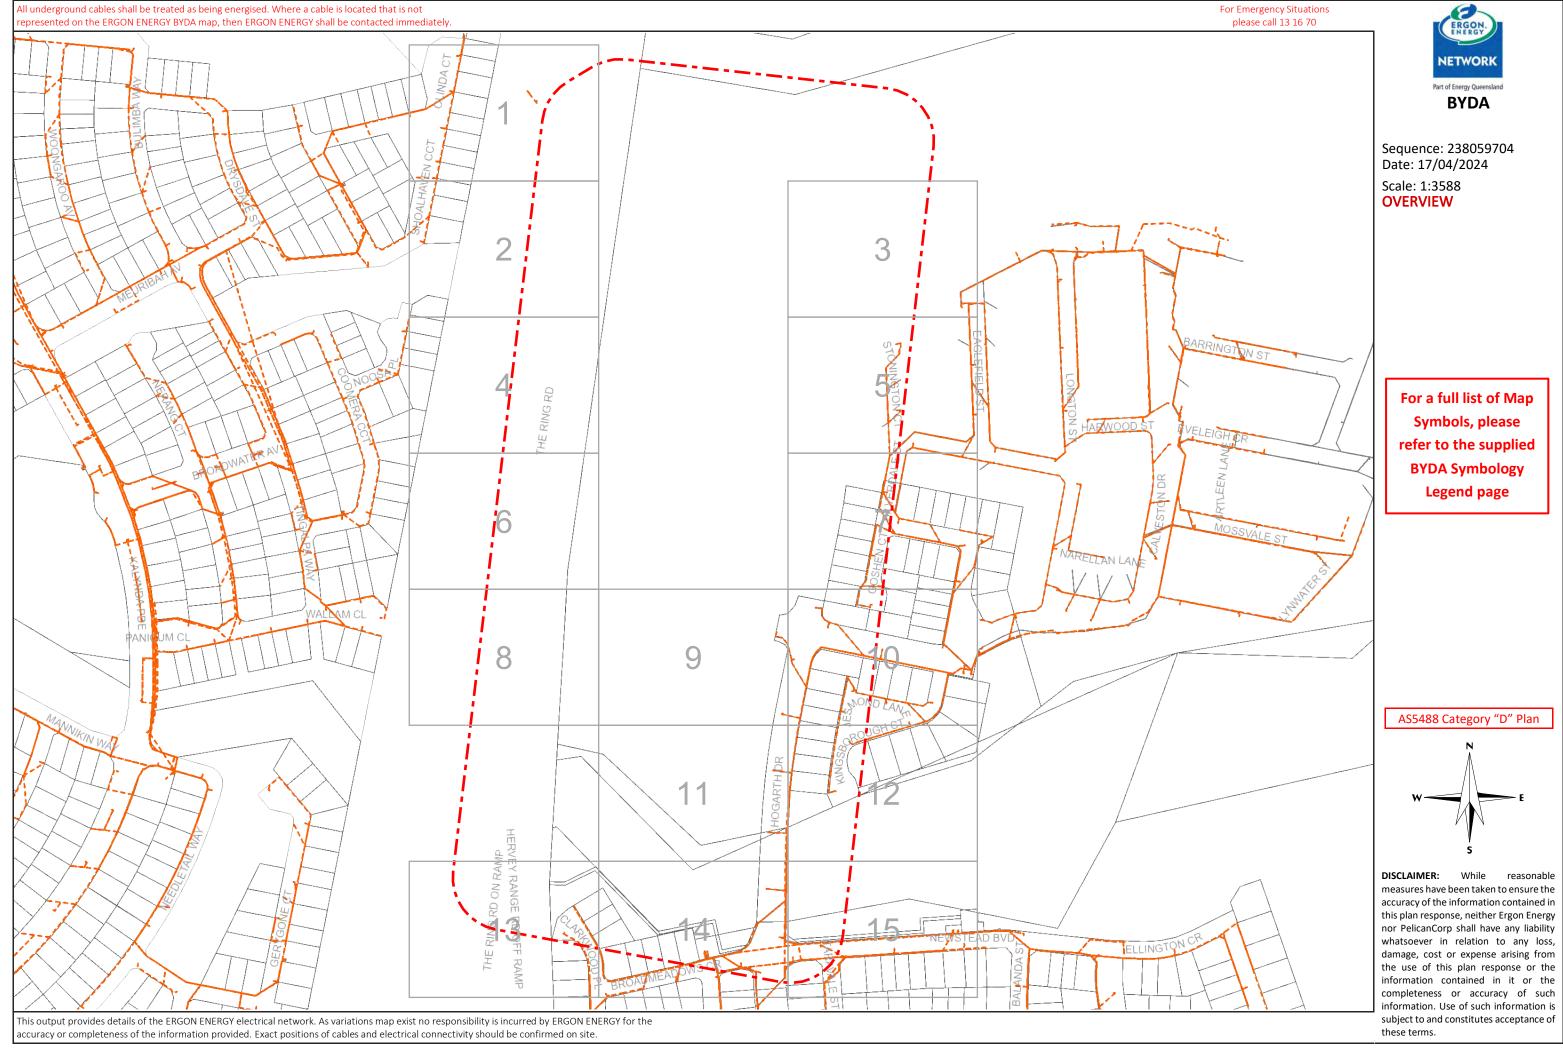


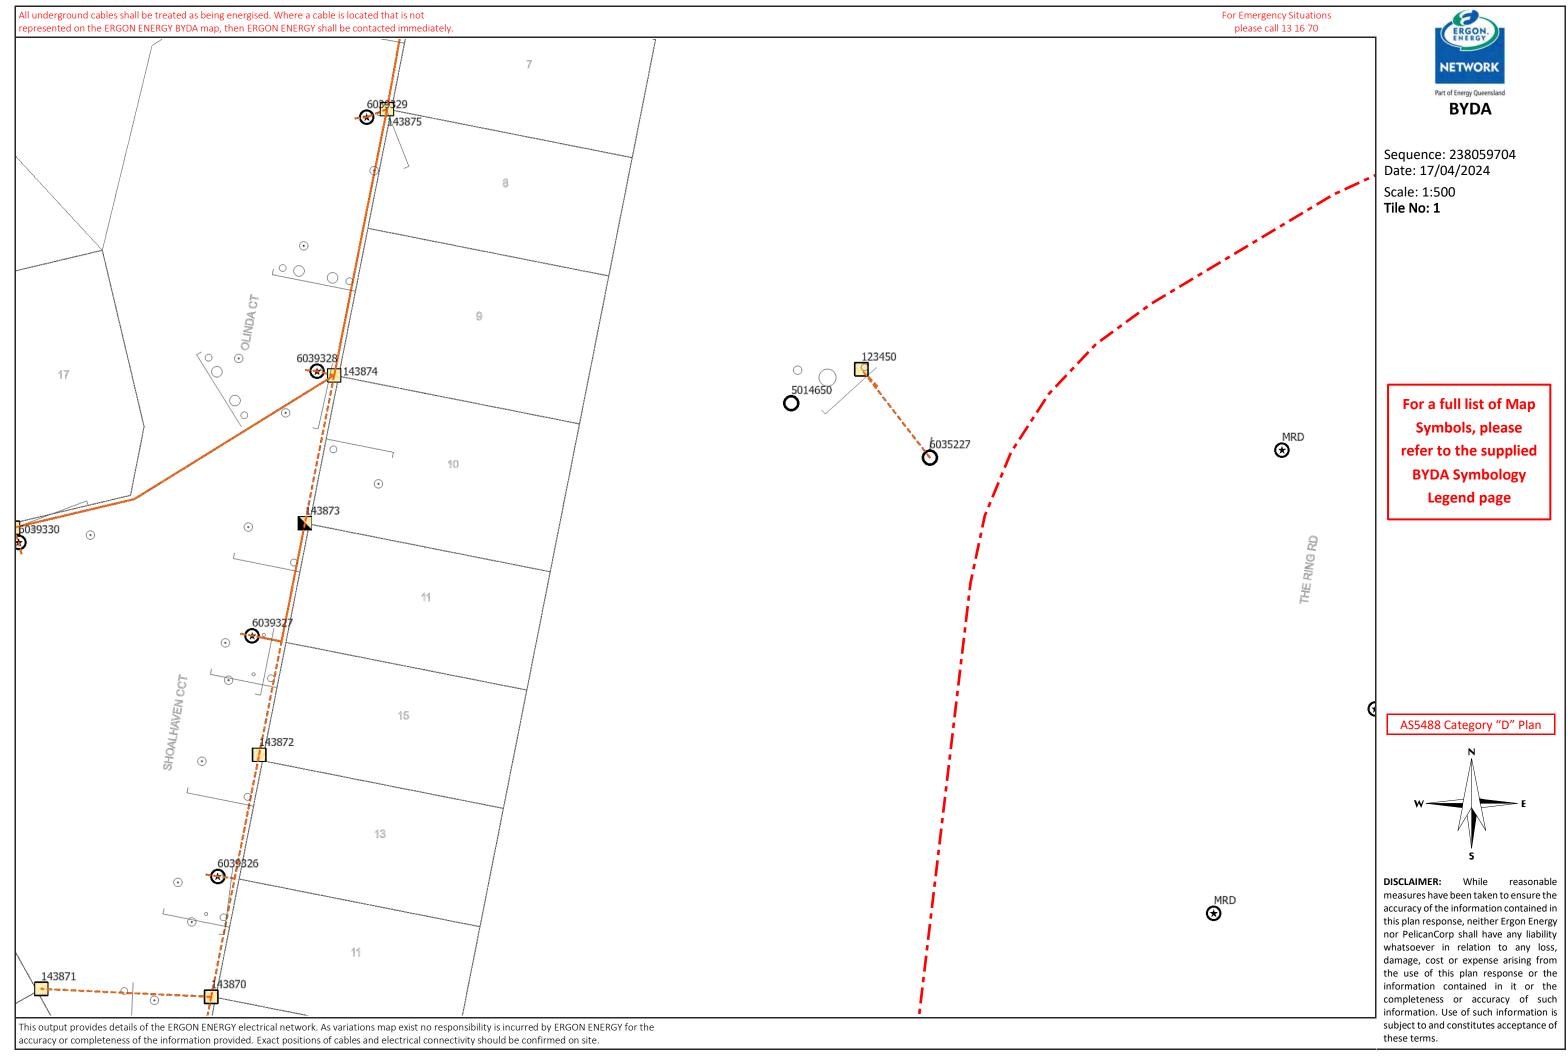


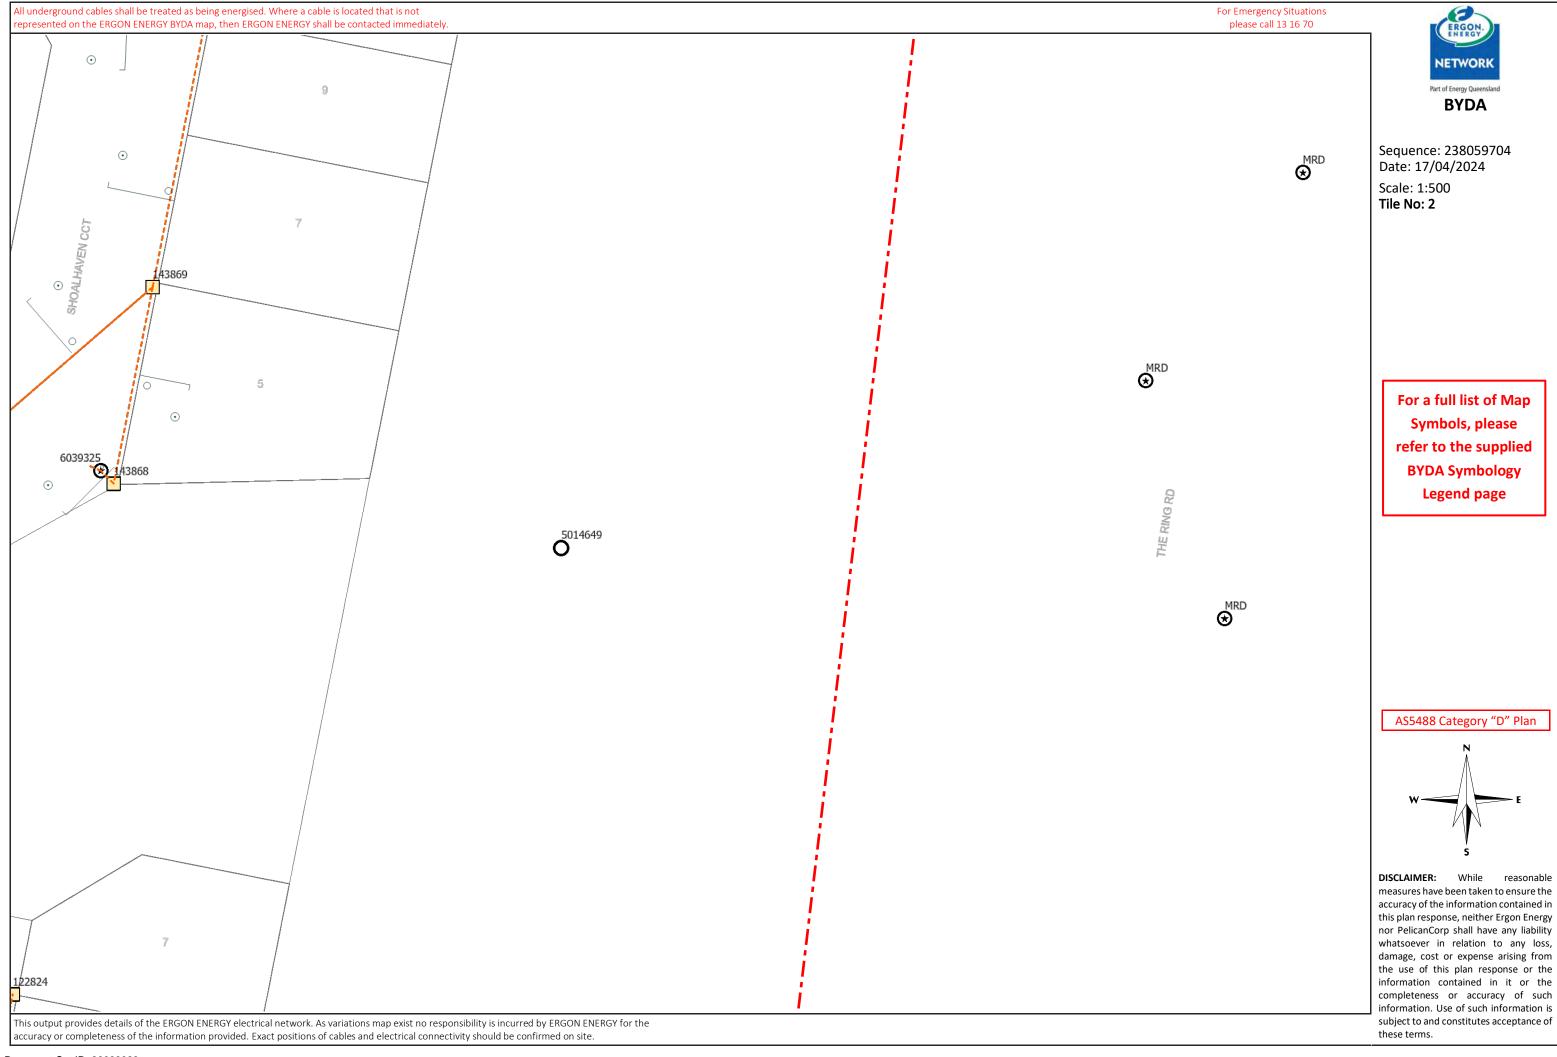


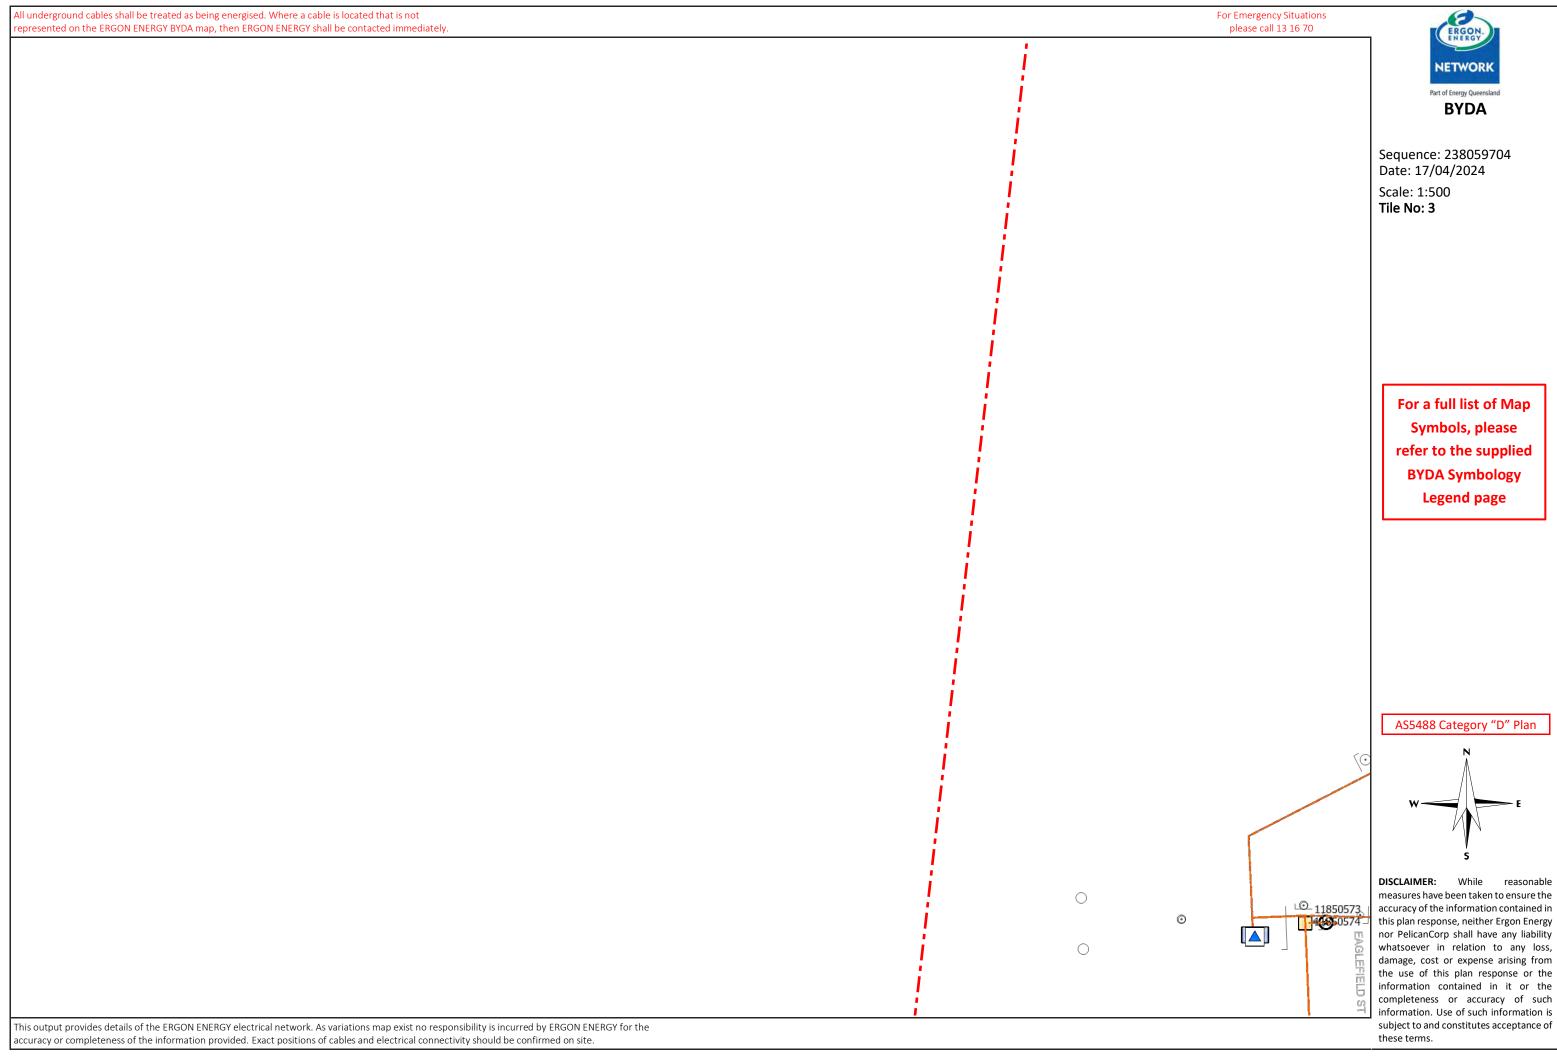


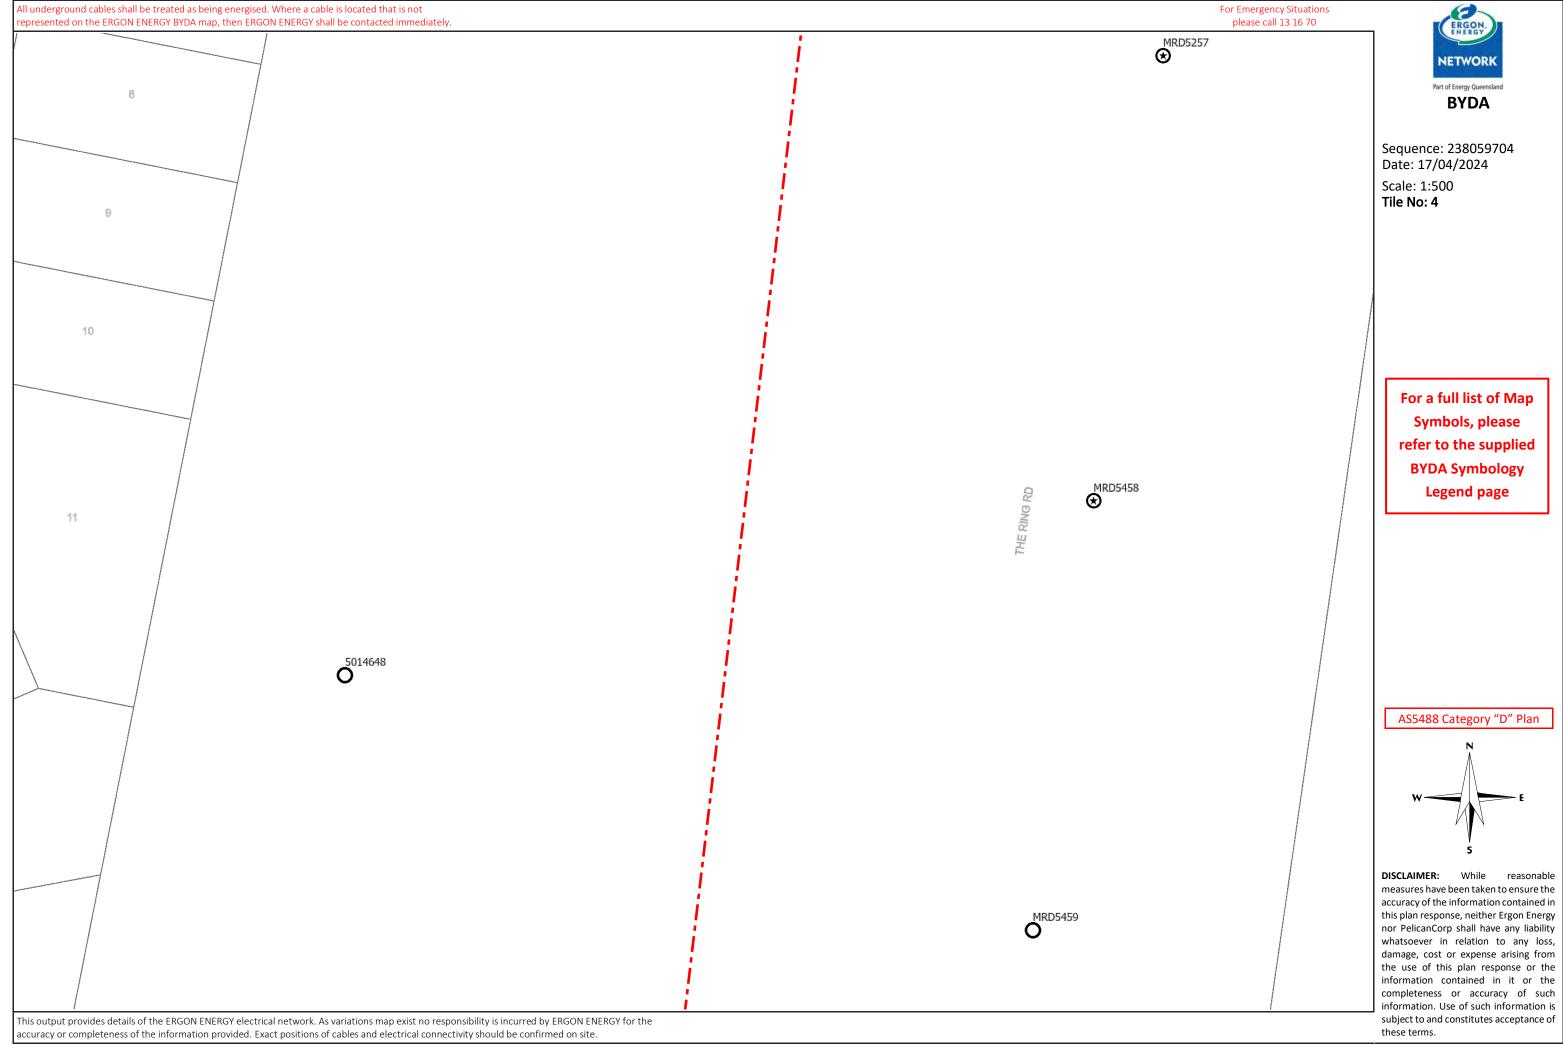

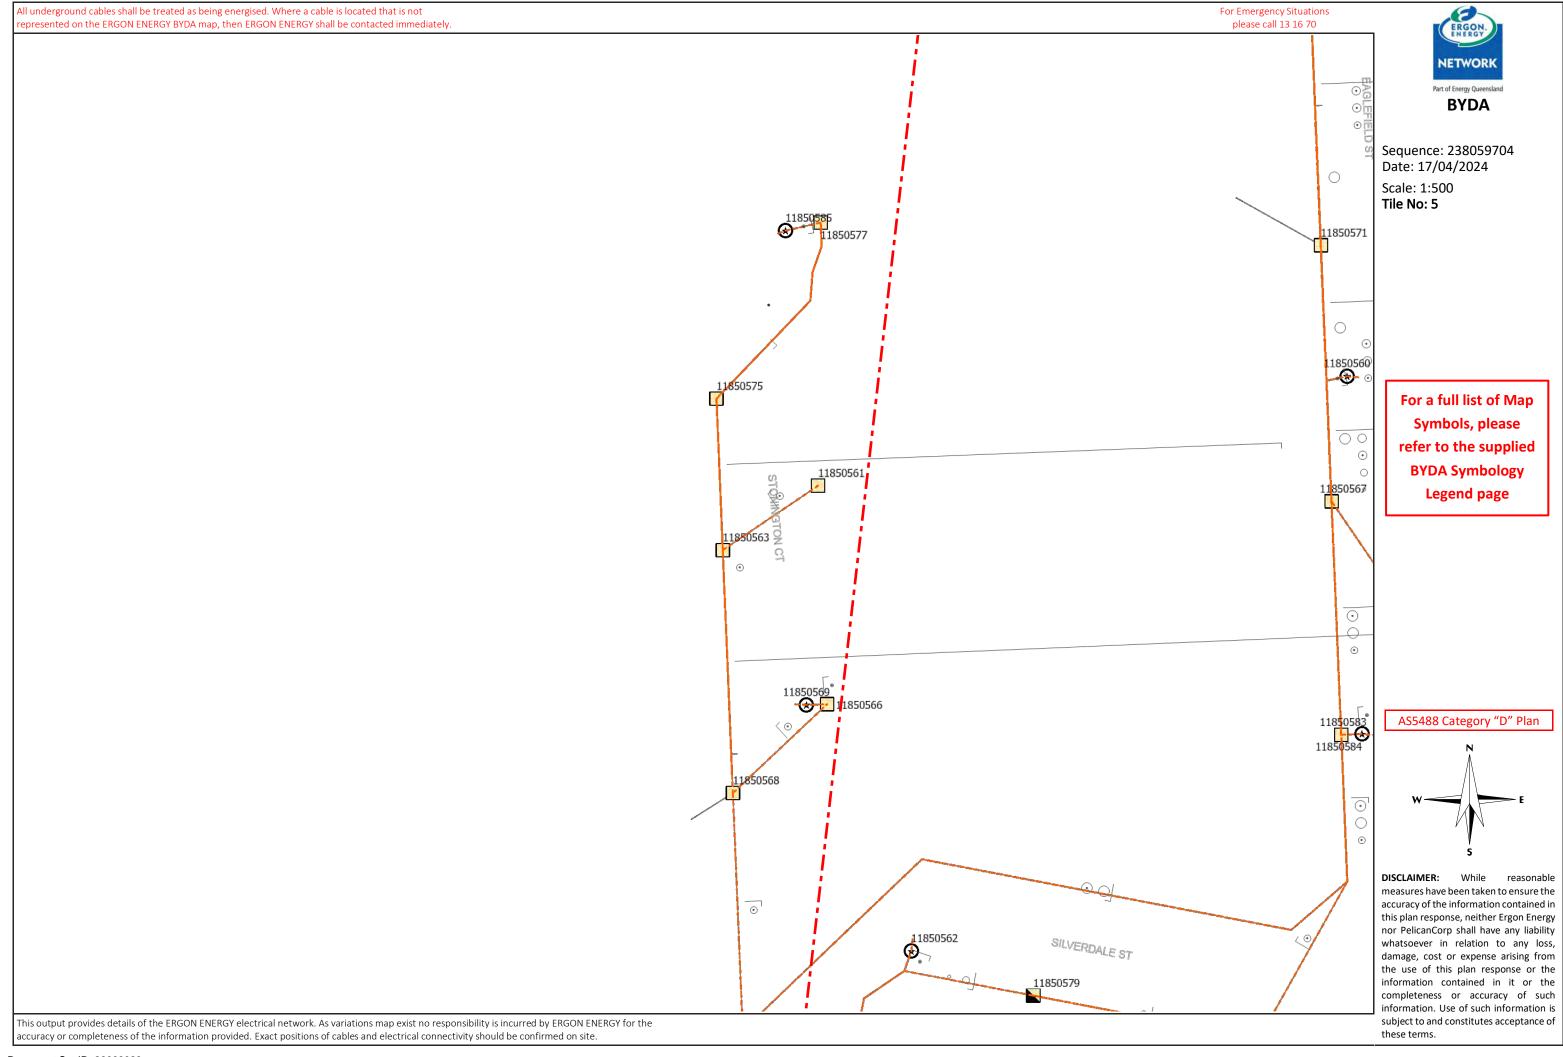

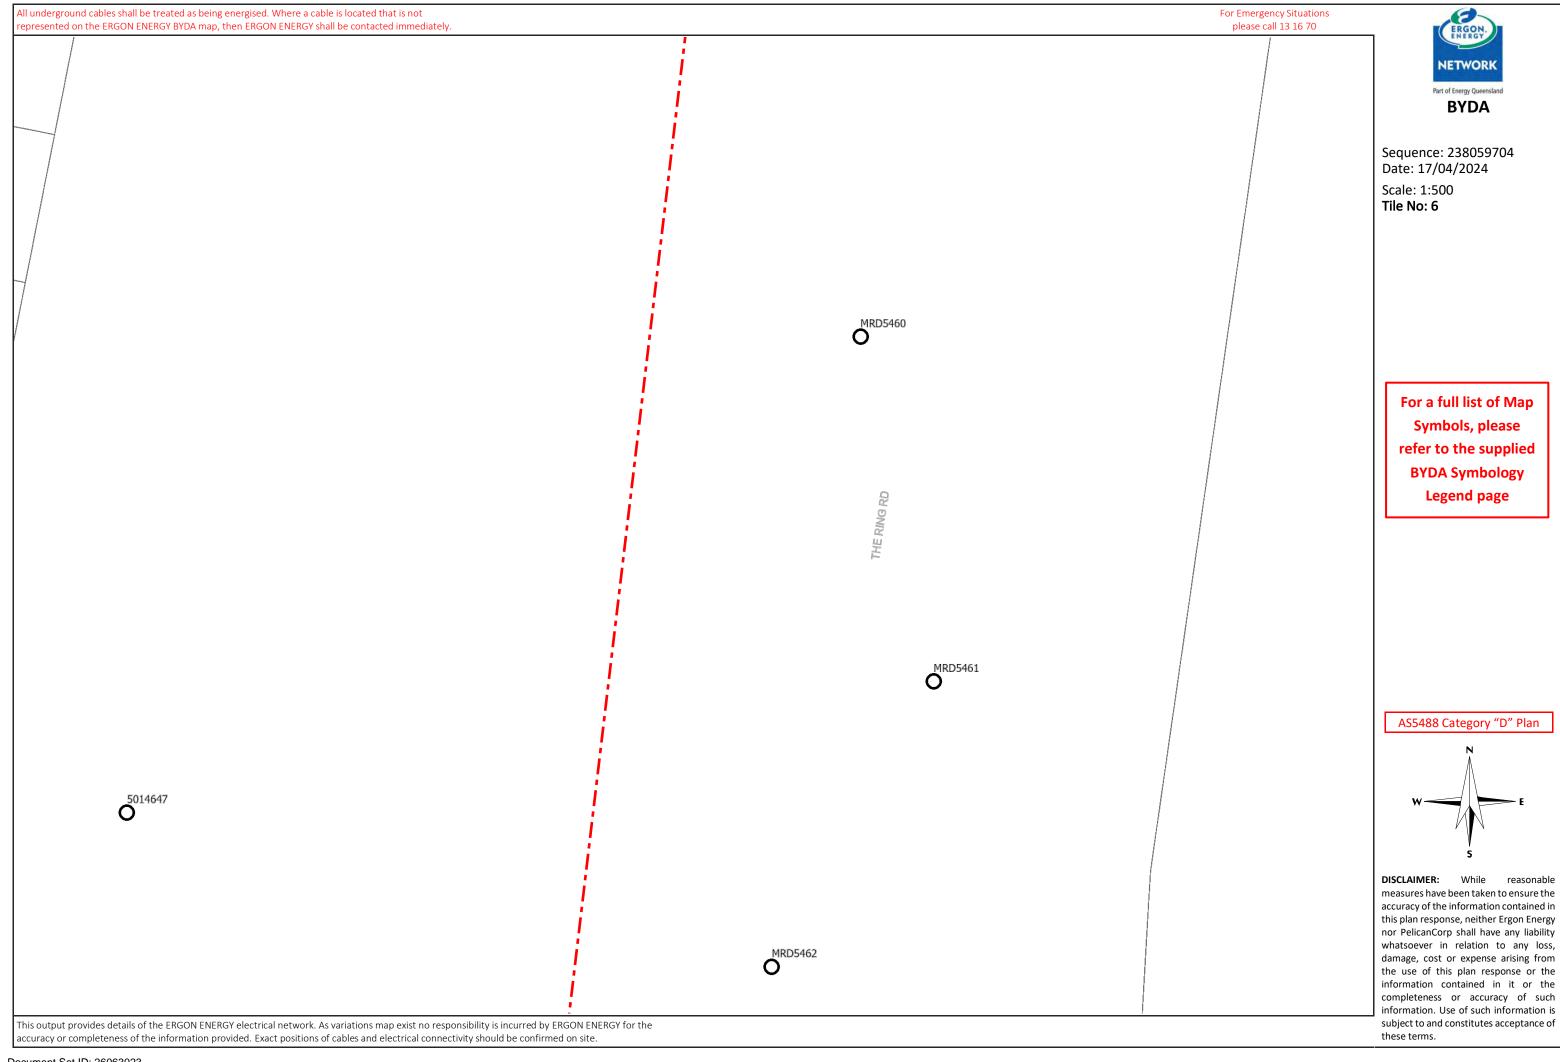

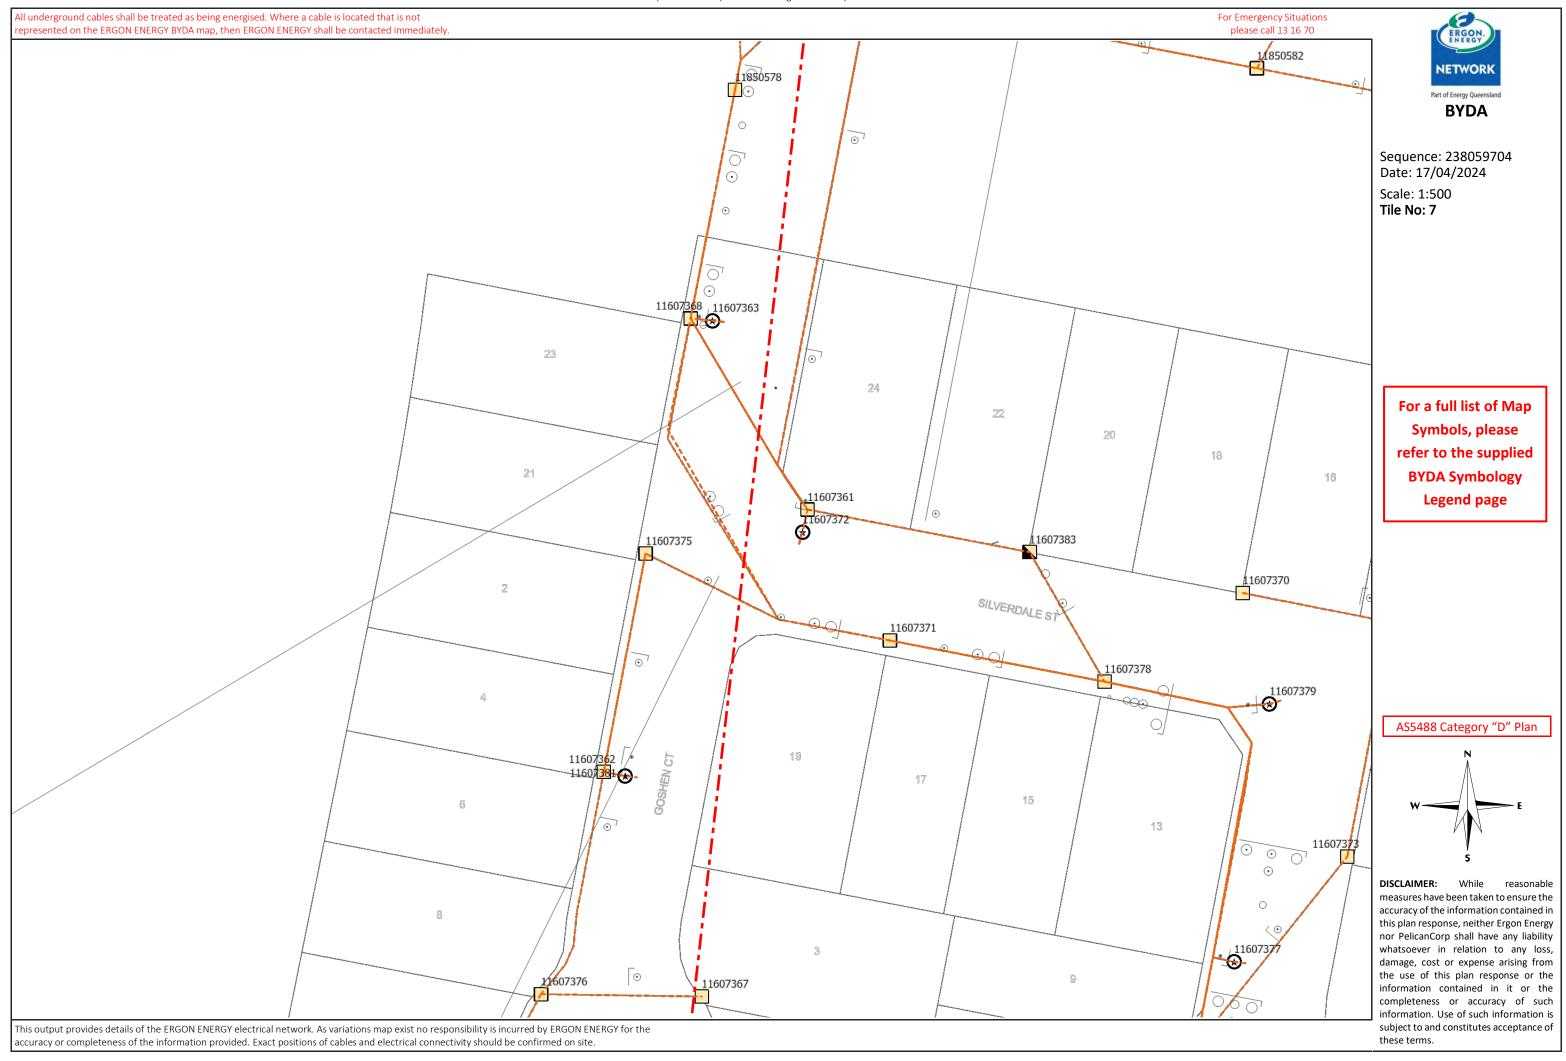

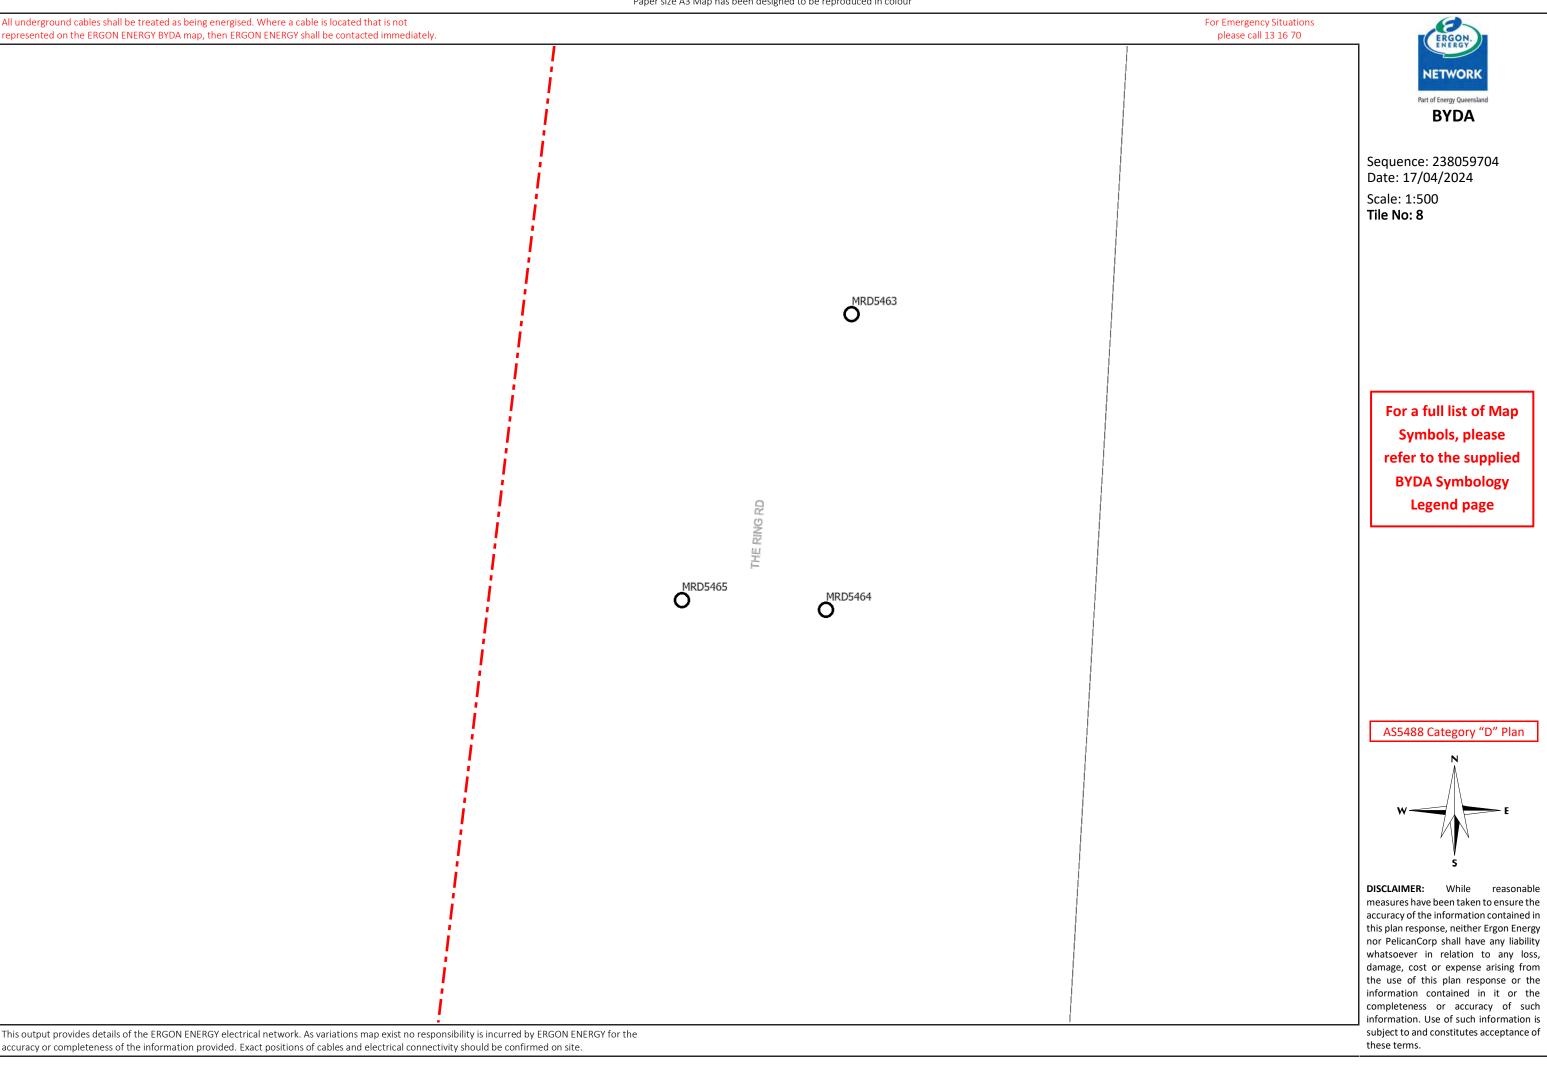



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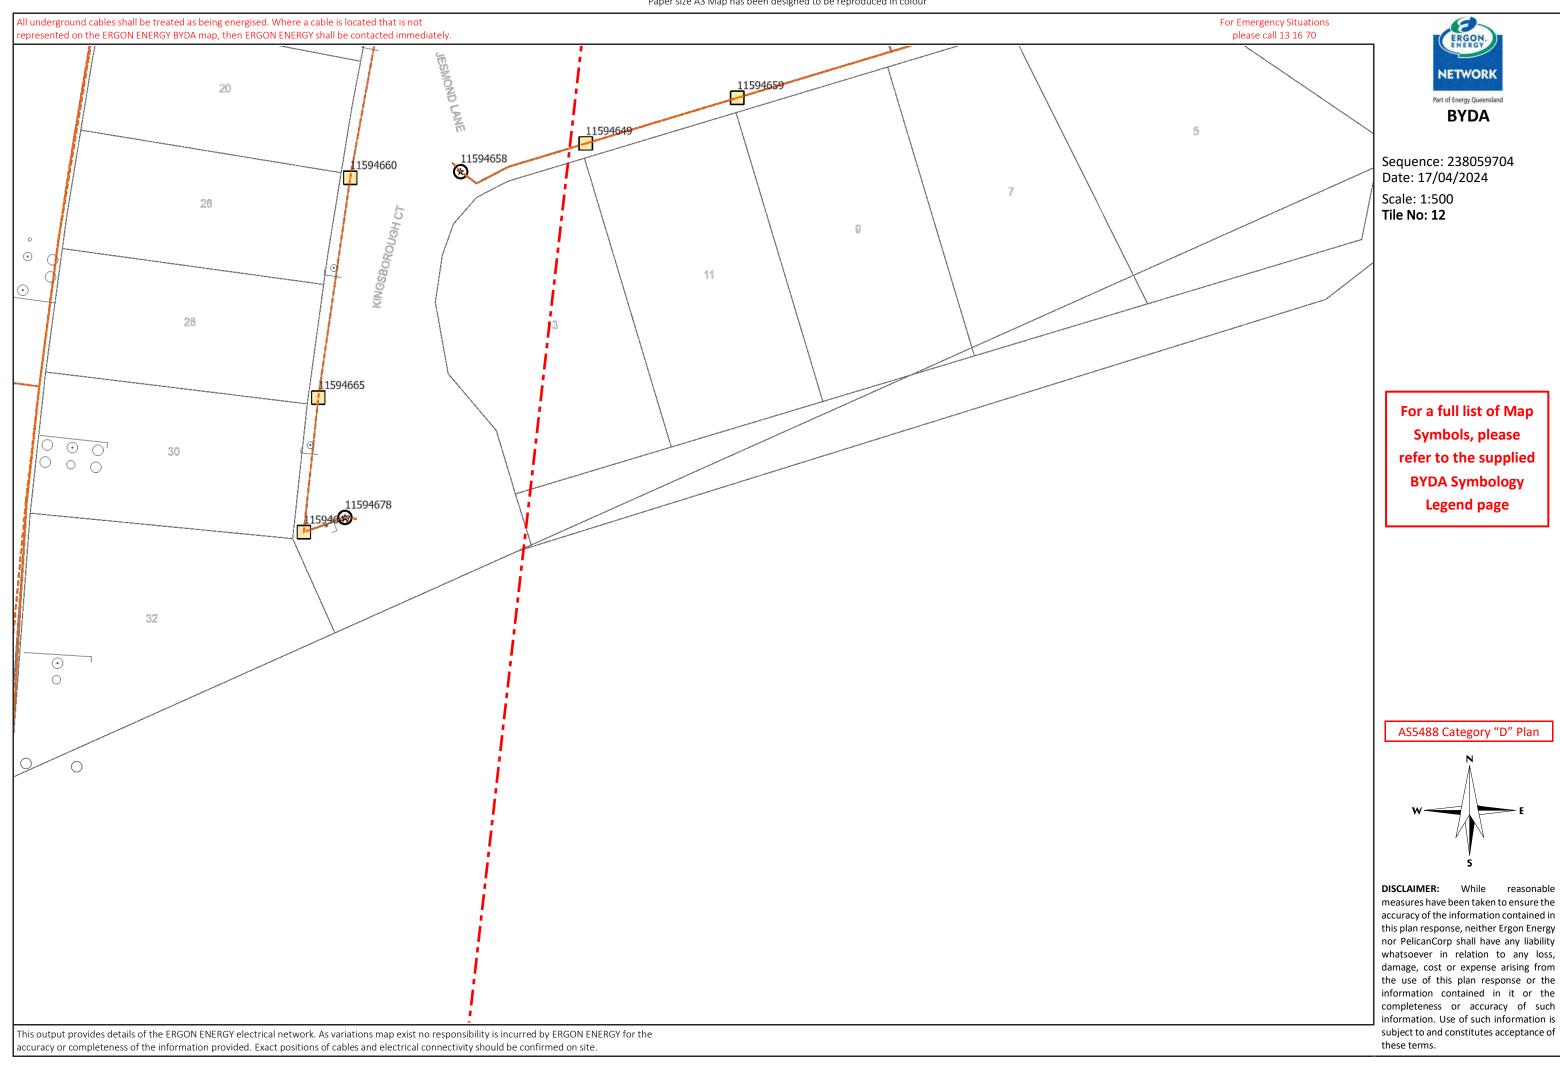
Symbols, please

Legend page


All underground cables shall be treated as being energised. Where a cable is located that is not For Emergency Situations represented on the ERGON ENERGY BYDA map, then ERGON ENERGY shall be contacted immediately. please call 13 16 70 **BYDA** Sequence: 238059704 Date: 17/04/2024 Scale: 1:500 Tile No: 9 11594672 For a full list of Map Symbols, please refer to the supplied **BYDA Symbology Legend page** AS5488 Category "D" Plan DISCLAIMER: While measures have been taken to ensure the accuracy of the information contained in 11594679 this plan response, neither Ergon Energy nor PelicanCorp shall have any liability whatsoever in relation to any loss, damage, cost or expense arising from the use of this plan response or the information contained in it or the completeness or accuracy of such information. Use of such information is subject to and constitutes acceptance of This output provides details of the ERGON ENERGY electrical network. As variations map exist no responsibility is incurred by ERGON ENERGY for the these terms. accuracy or completeness of the information provided. Exact positions of cables and electrical connectivity should be confirmed on site.




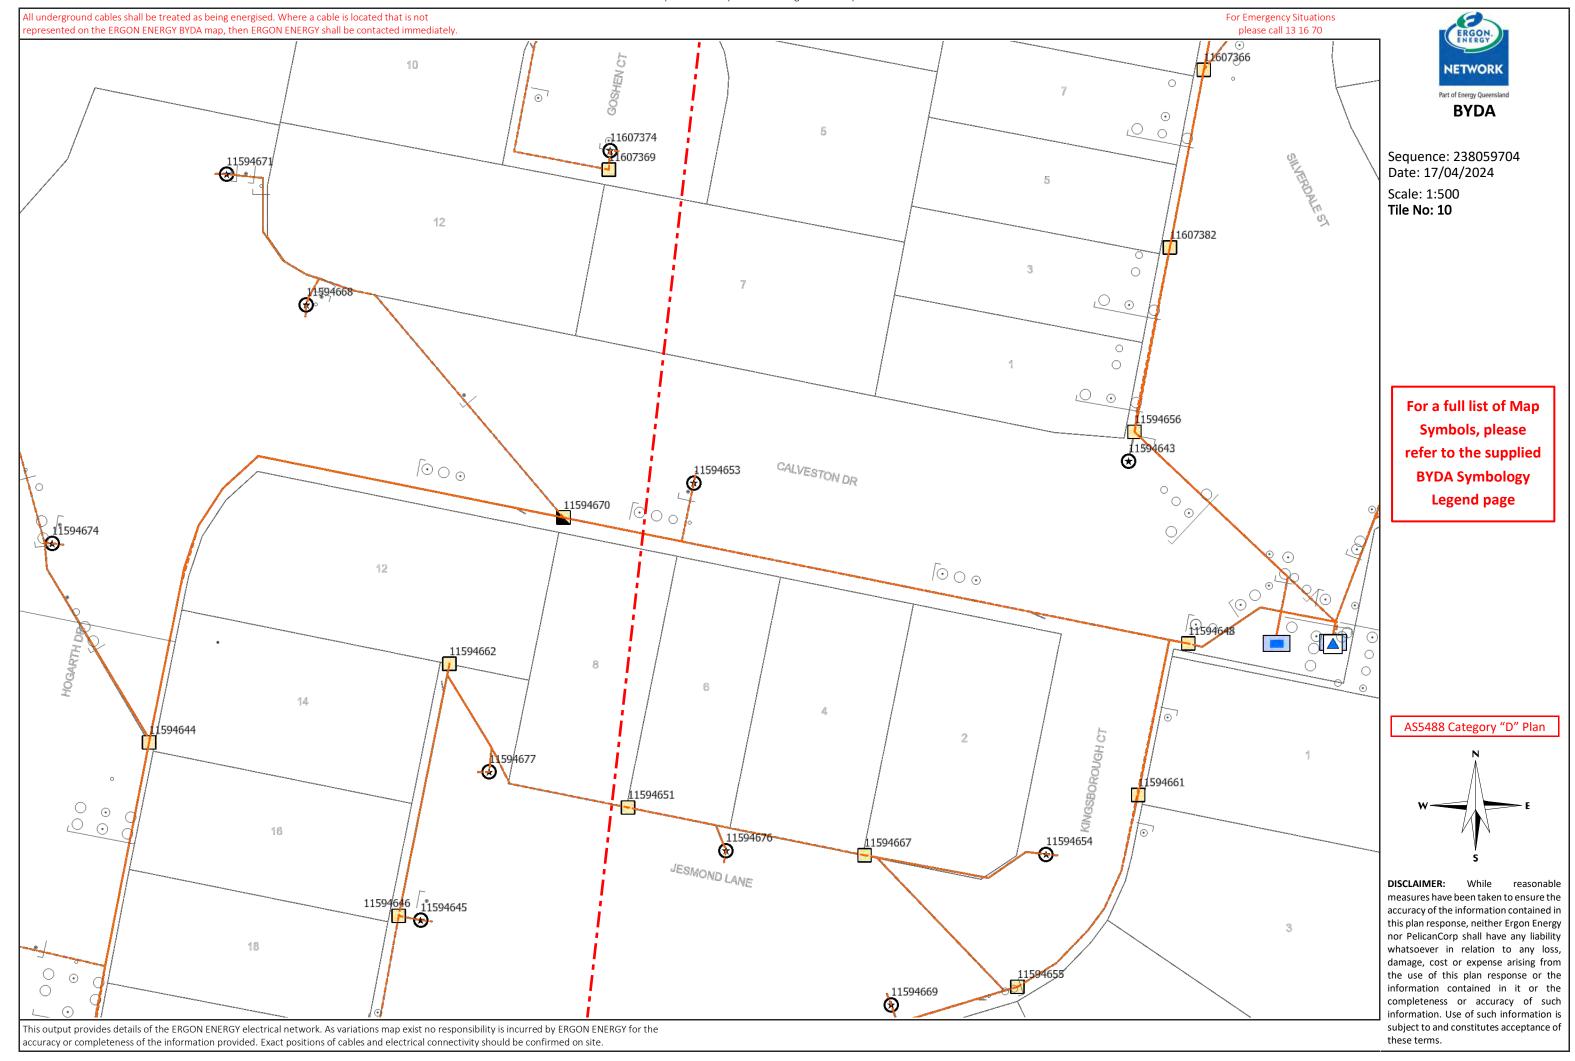


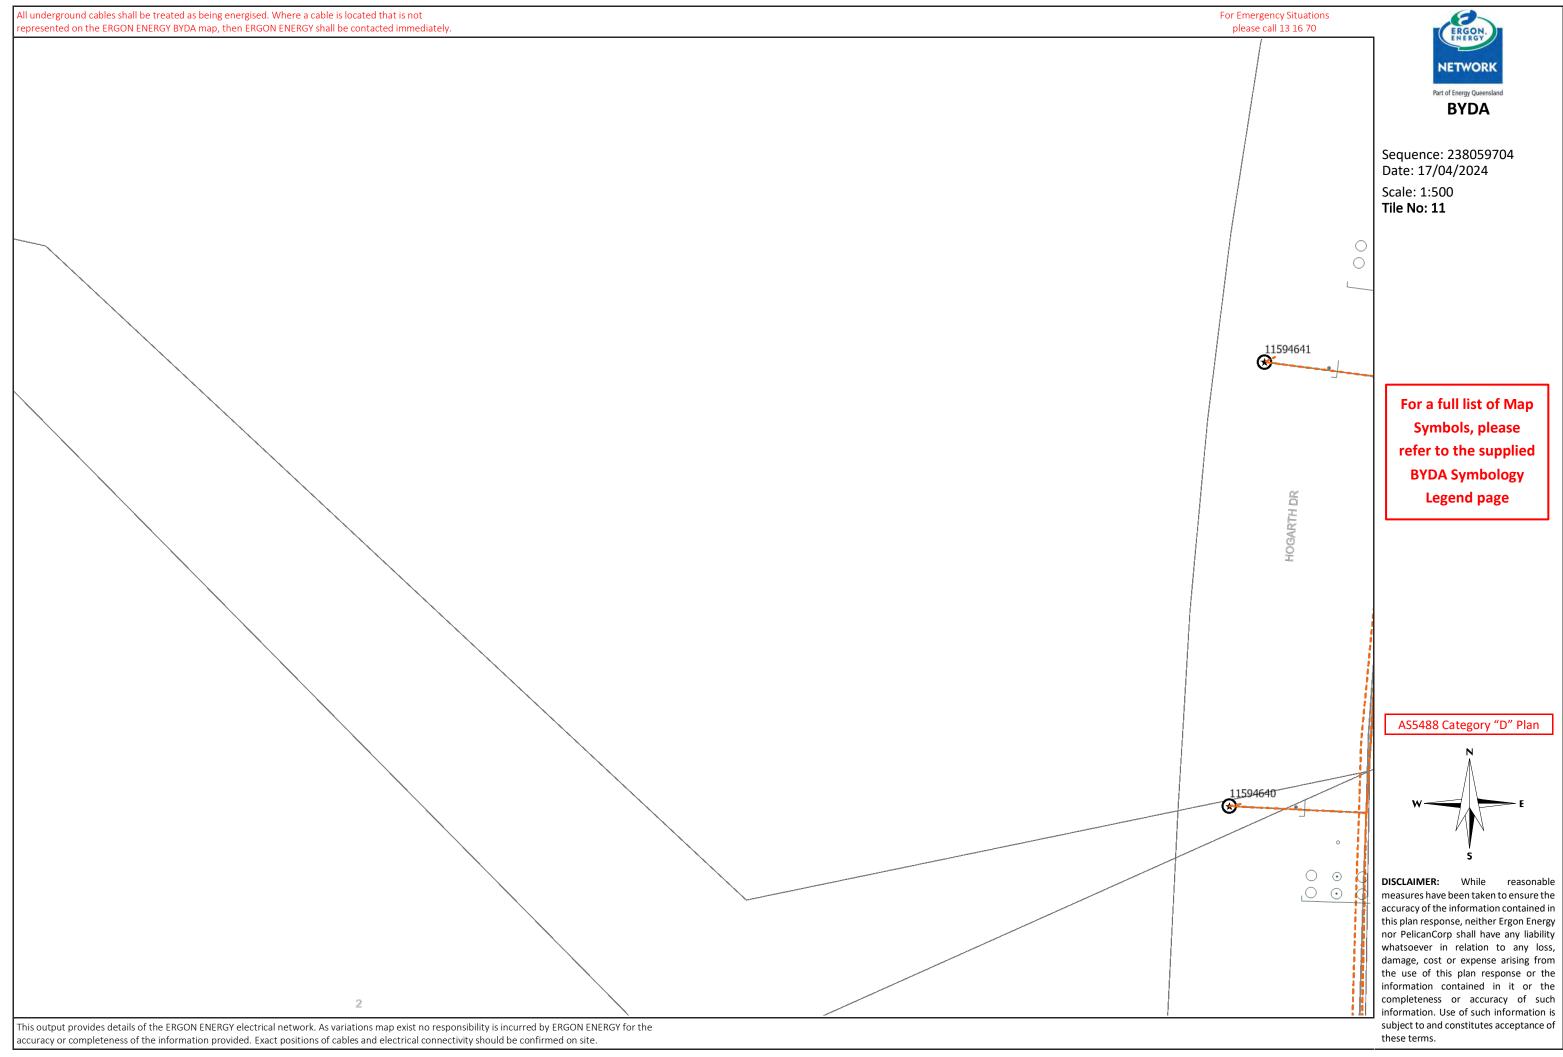

Part of Energy Queensland **BYDA**

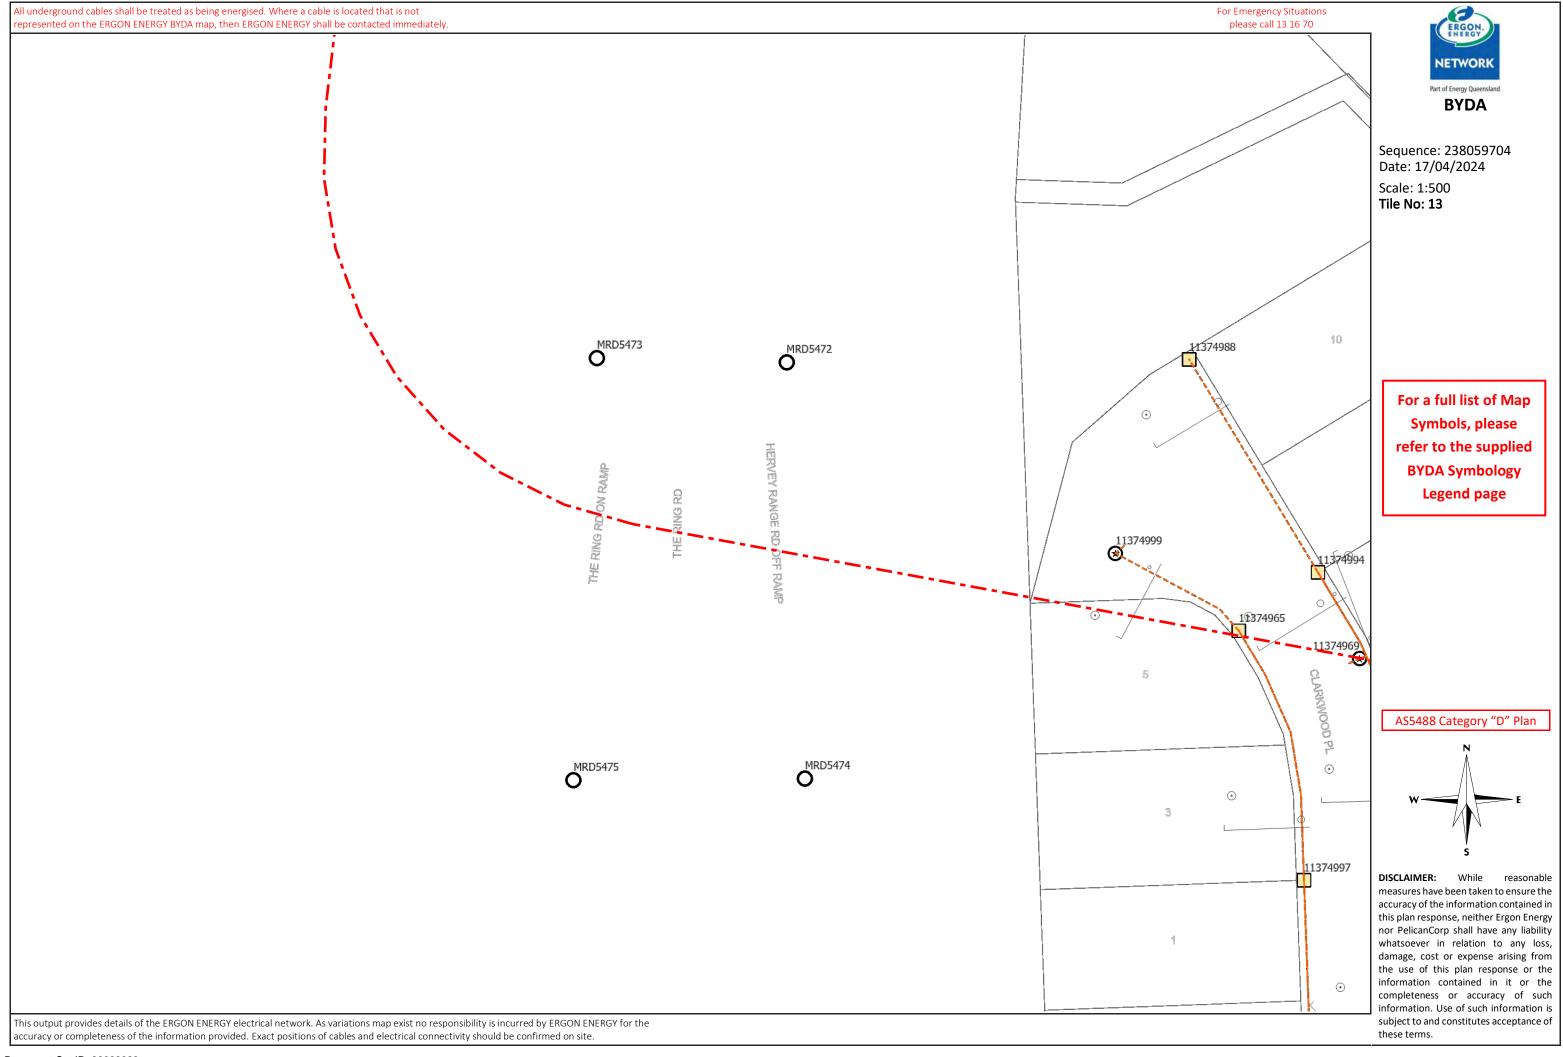

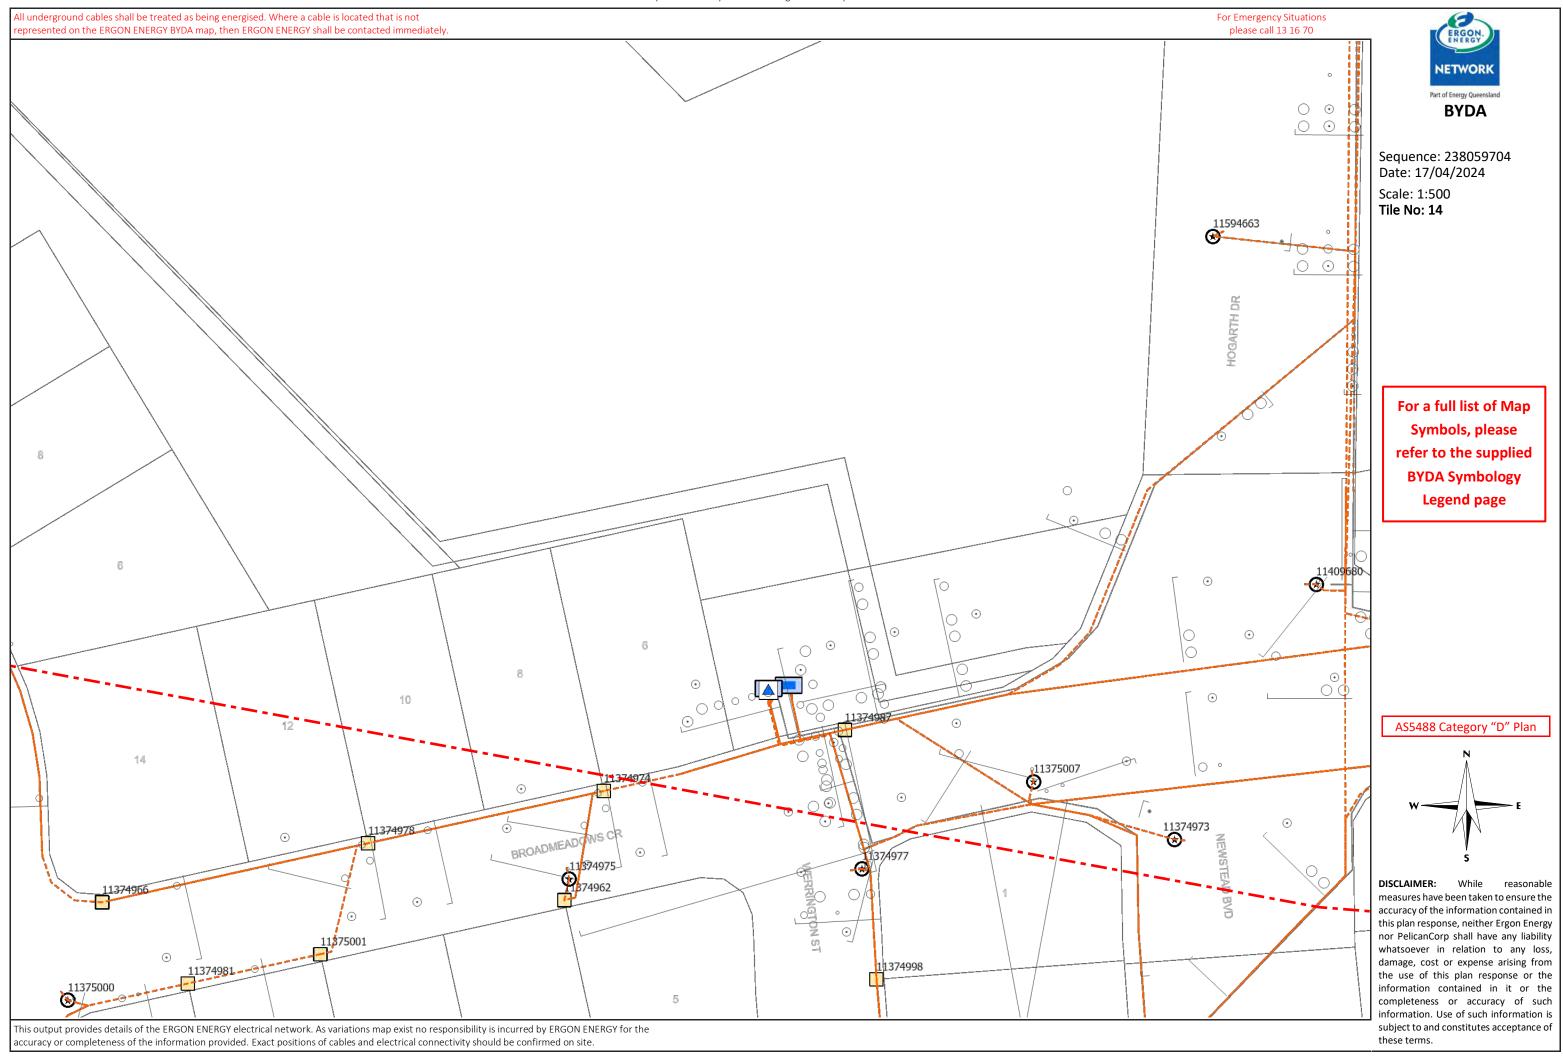

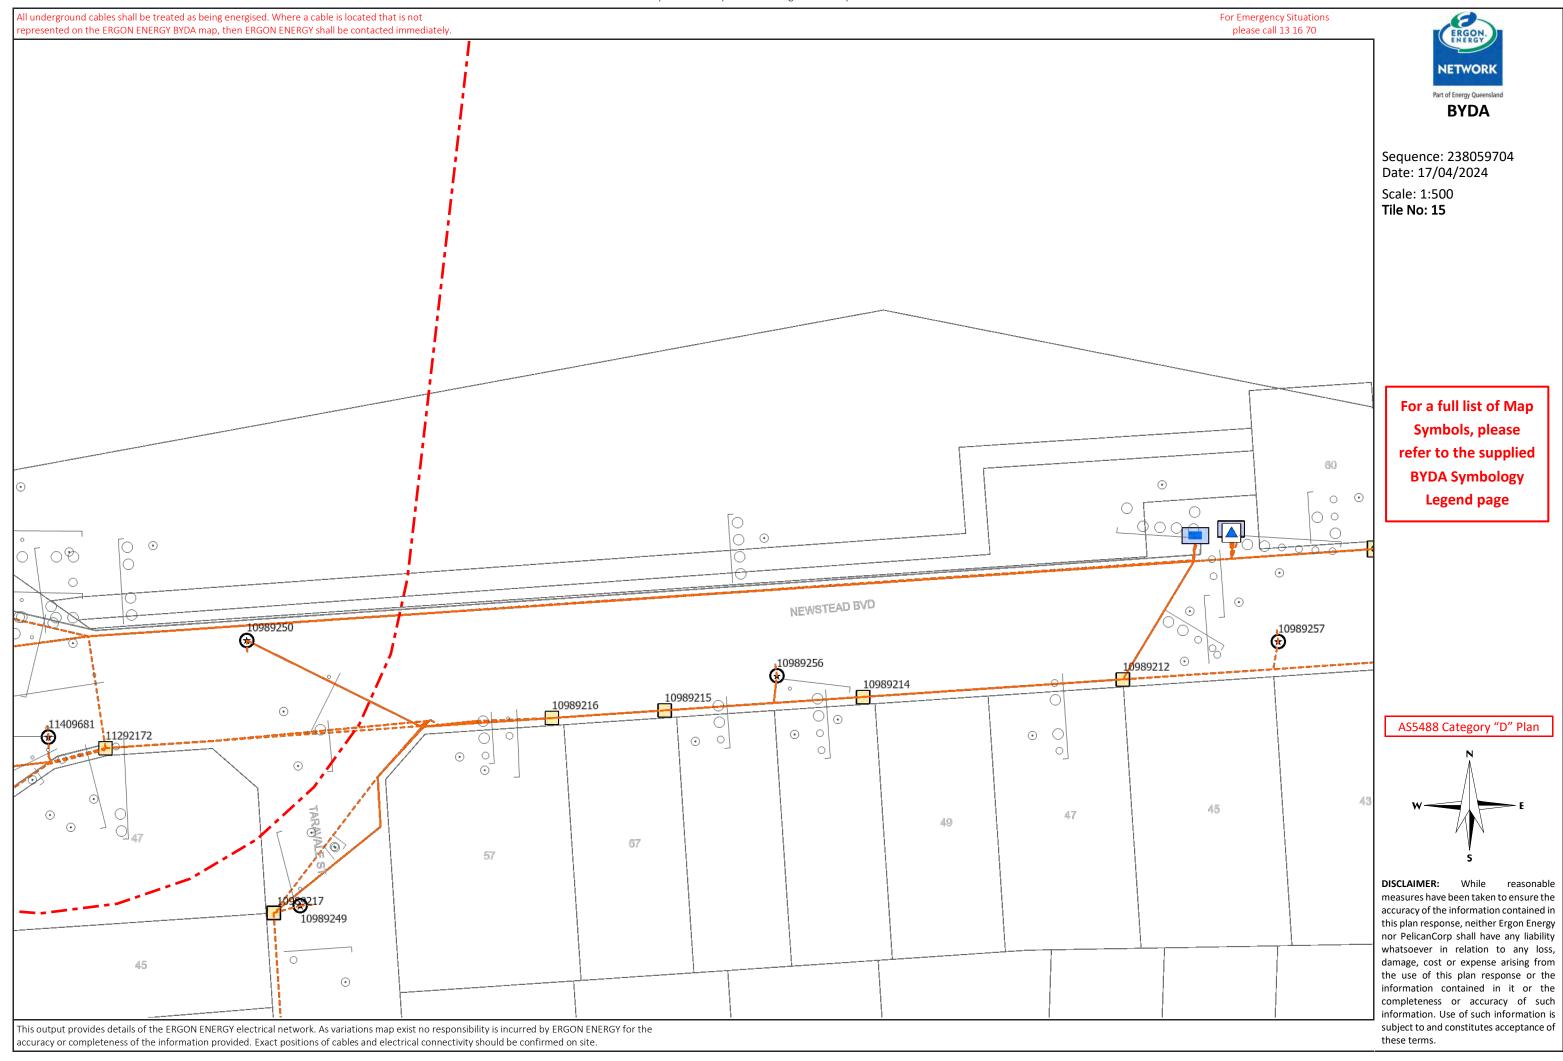

BYDA terms and conditions

Duty of care for everyone

The following matters must be considered when working near Ergon Energy electrical equipment:

The PCBU must ensure, so far as is reasonably practicable, that no person, plant or thing at the workplace comes within an unsafe distance of an underground electric line (see section 68 of the Electrical Safety Regulation 2013)

- 1. It is the responsibility of the architect, consulting engineer, developer, and head contractor in the project planning stages to design for minimal impact and protection of Ergon Energy electrical equipment.
- 2. It is the constructor's responsibility to:
 - a) Anticipate and request plans of Ergon Energy electrical equipment for a location at a reasonable time before construction begins.
 - b) Visually locate Ergon Energy electrical equipment by hand or vacuum excavation where construction activities may damage or interfere with Ergon Energy electrical equipment.
 - c) To notify Ergon Energy if the information provided is found to be not accurate or assets are found on site that are not recorded on the Ergon Energy BYDA plans.
 - d) Read and understand all the information and disclaimers provided.


Note: A constructor may include but not limited to a PCBU, Designer, Project Manager, Installer, Contractor or a Civil Contractor

- 3. Comply with applicable work health and safety and electrical safety codes of practice including but not limited to:
 - a) Working near overhead and underground electric lines Electrical safety codes of practice 2020
 - b) Managing electrical risk in the workplace Electrical safety code of practice 2013
 - c) Managing the risks of plant in the workplace Electrical safety code of practice 2013
 - d) Excavation work Electrical safety code of practice 2013


IMPORTANT NOTES:


- As the alignment and boundaries of roadways with other properties (and roads within roadways) frequently change, the alignments and boundaries contained within Ergon Energy plans and maps will frequently differ from present alignments and boundaries "on the ground". Accordingly, in every case where it appears that alignments and boundaries have shifted, or new roadways have been added, the constructor should obtain confirmation of the actual position of Ergon Energy cables and other electrical equipment under the roadways. In no case should the constructor rely on statements of third parties in relation to the position of Ergon Energy cables and pipelines. It is the applicant's responsibility to accurately locate all services as part of the design and/or prior to excavation.
- Ergon Energy does not provide information on private underground installations, including consumers' mains that may run from Ergon Energy mains onto private property. Assets located on private property are the responsibility of the owner for identification and location
- Ergon Energy plans are circuit diagrams or pipe indication diagrams only and indicate the presence of plant in the general vicinity of
 the geographical area shown. Exact ground cover and alignments cannot be given with any certainty; as such levels can change
 over time.
- All underground conduits are presumed to contain asbestos. Refer to "Code of Practice for the Management and Control of Asbestos in Workplaces [NOHSC: 2018 (2005)] -https://www.safeworkaustralia.gov.au/system/files/documents/1702/codeofpracticeformanagementcontrolofasbestosintheworkplace_noh_sc2018-2005
- Plans provided by Ergon Energy do not show the presence of any Overhead Network.
- In addition to underground cables marked on attached plan there maybe underground Earth Conductors in the vicinity of the nominated work area(s) that are not marked on the plans.
- There may also be other buried assets such as tanks for fluid filled cables that do not appear on GIS plots but are shown on detailed as constructed drawings.
- Being aware of your obligations in [s 304] Excavation work— underground essential services information under the Work Health and Safety Regulation 2011, Chapter 6 Construction work, Part 6.3 Duties of person conducting business or undertaking. This includes but is not limited to taking reasonable steps to obtain the current information and providing this information to persons engaged to carry out the excavation work. For further information please refer to: http://www.legislation.gld.gov.au/LEGISLTN/SLS/2011/11SL240.pdf
- Ergon Energy plans are designed to be printed in colour and as an A4 Landscape orientation


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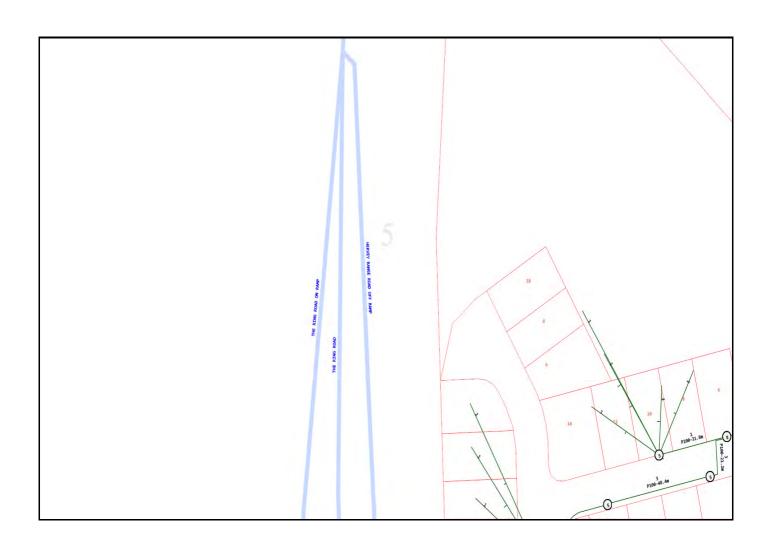


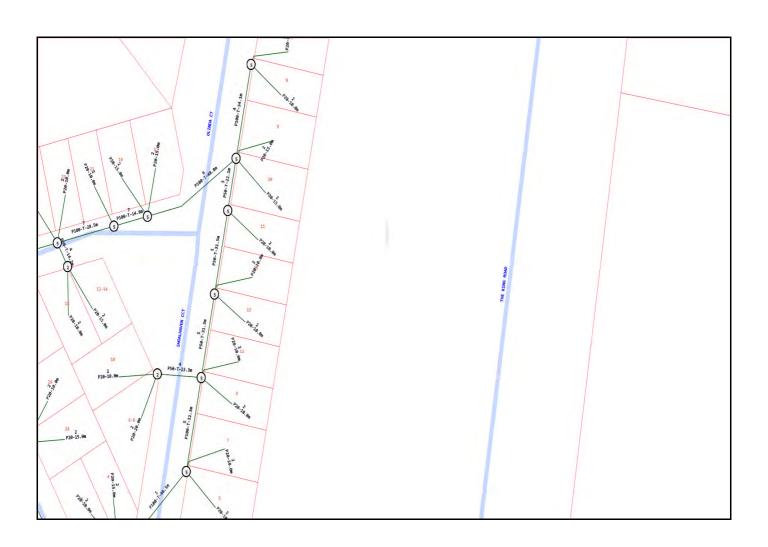
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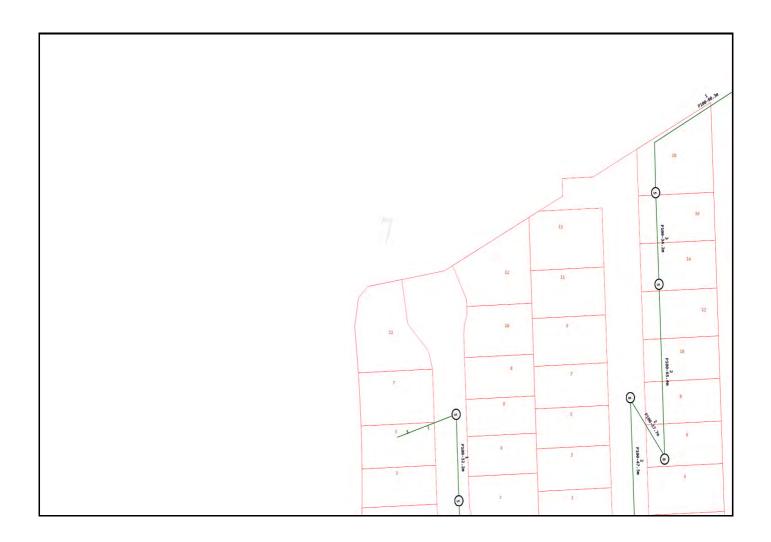




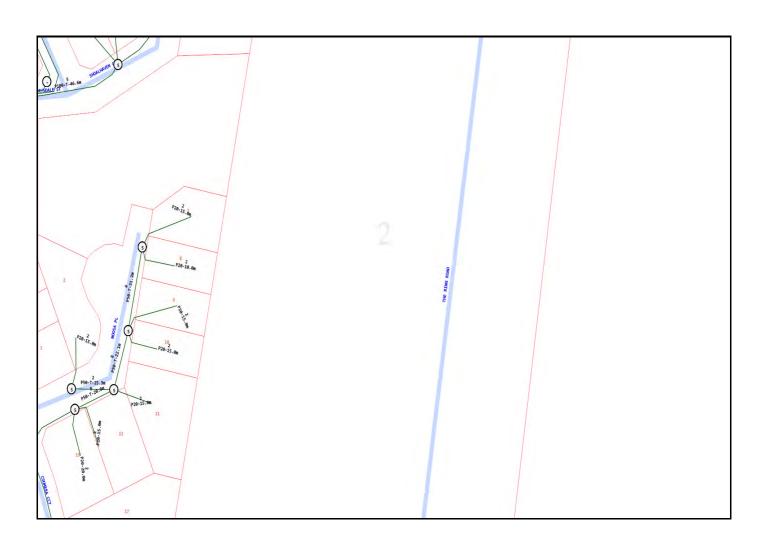

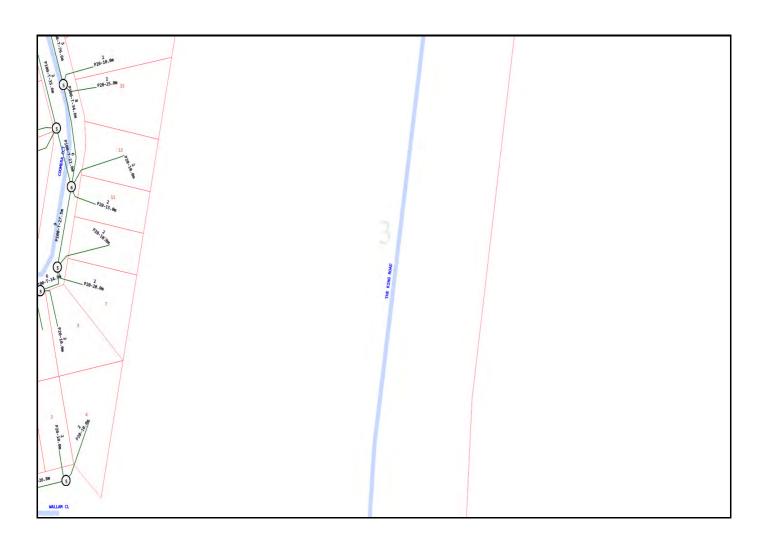


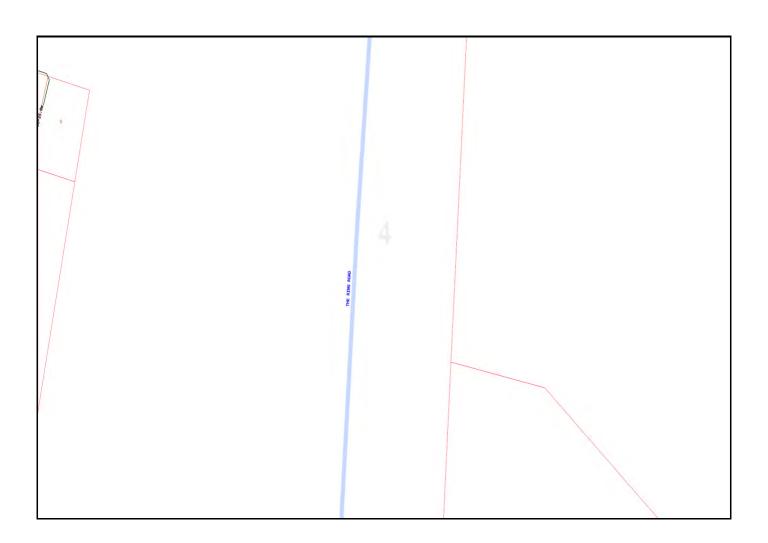

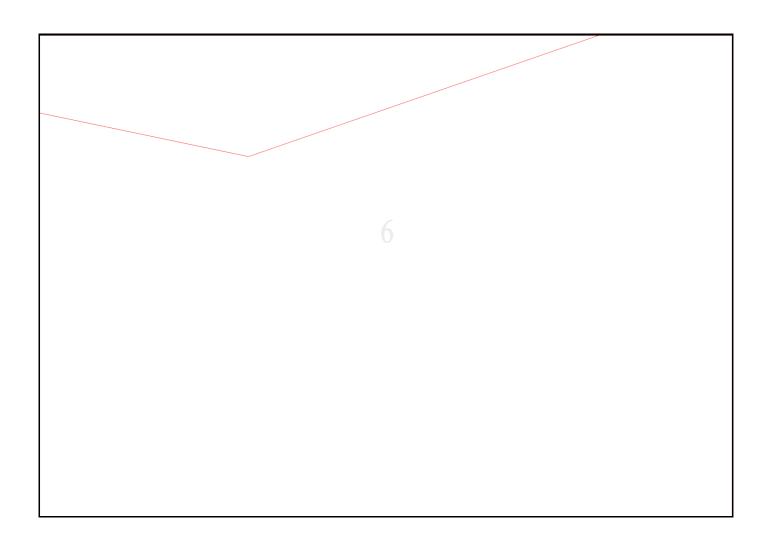





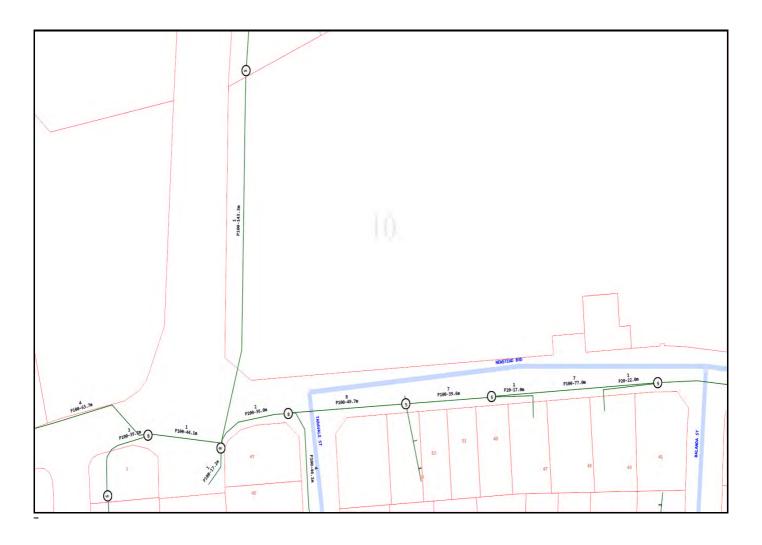


Emergency Contacts

You must immediately report any damage to the ${\bf nbn}^{\sf m}$ network that you are/become aware of. Notification may be by telephone - 1800 626 329.



Overview Map


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Map 1

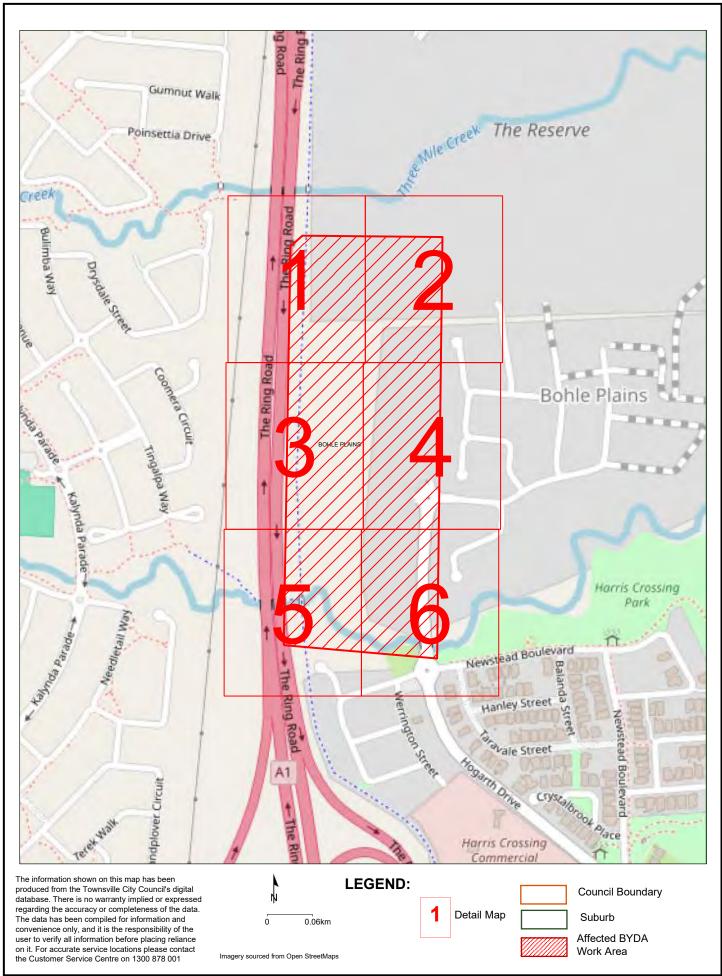
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Map 2


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Map 3


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Map 4

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Map 5

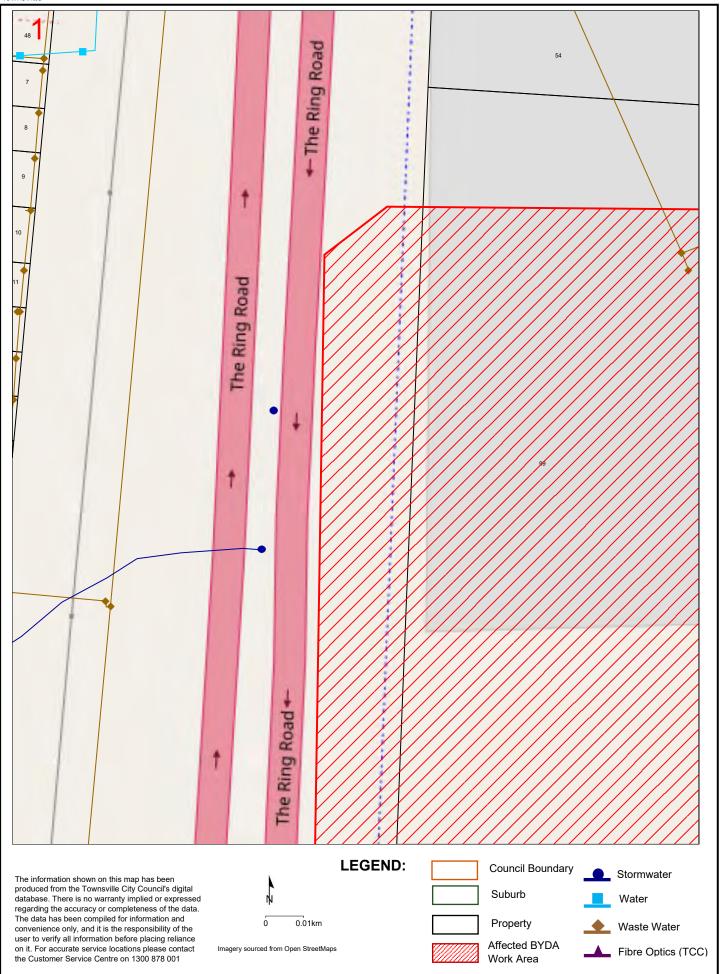
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Map 6

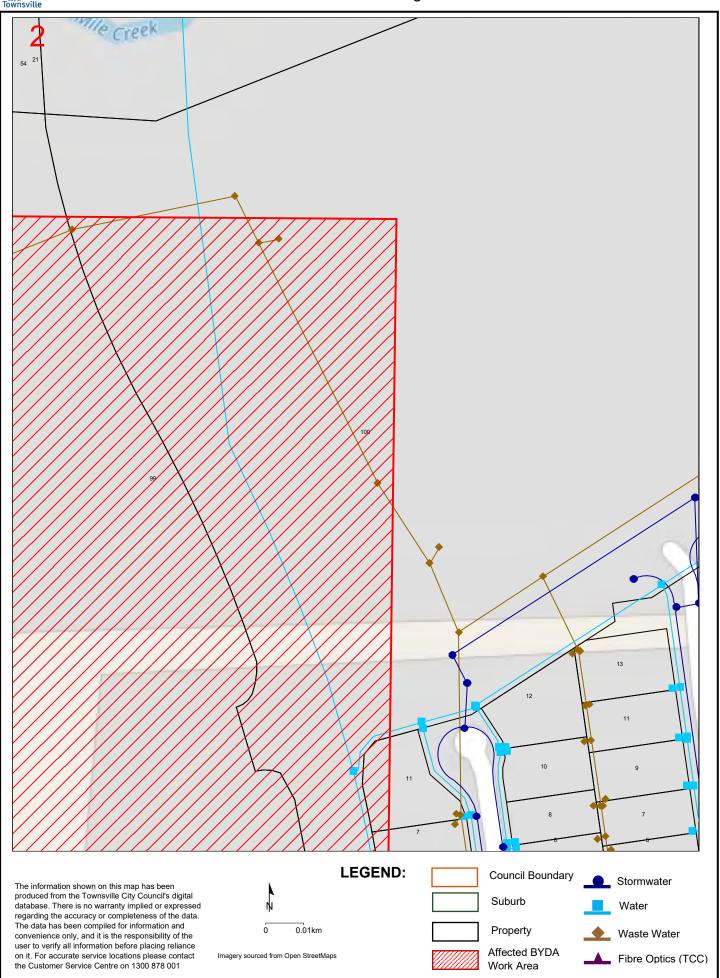Sequence No: 238059703

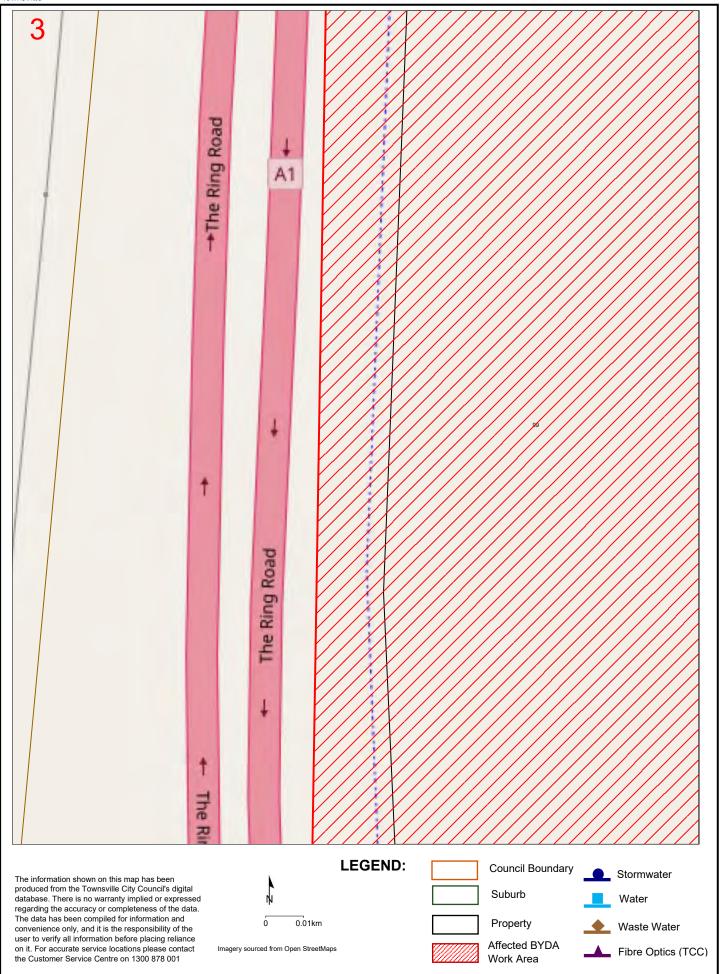

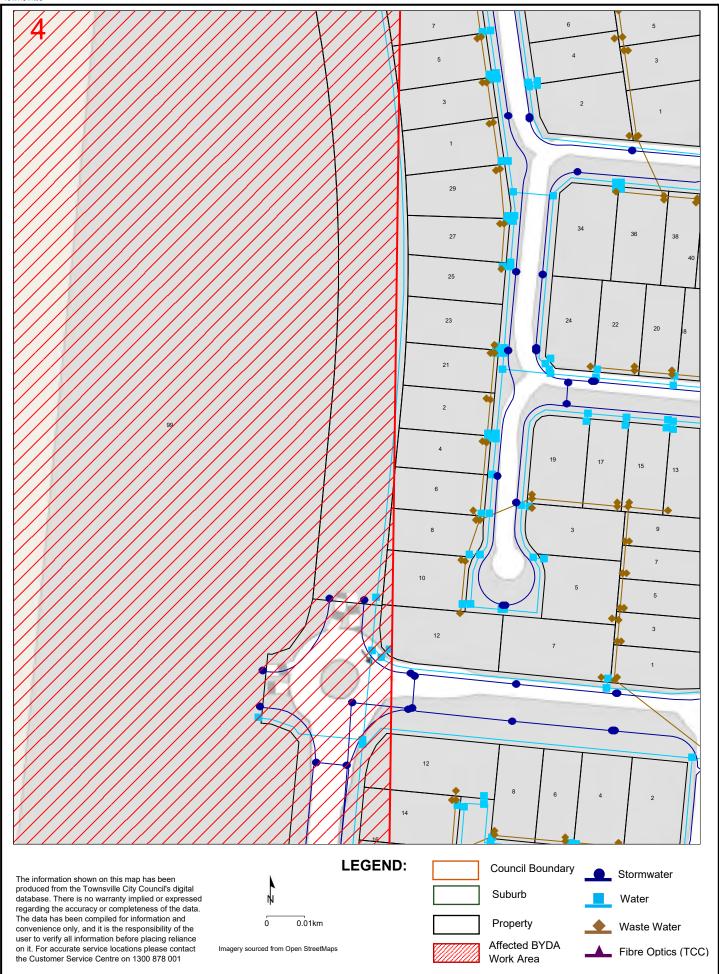

Appendix C - Engineering Plans

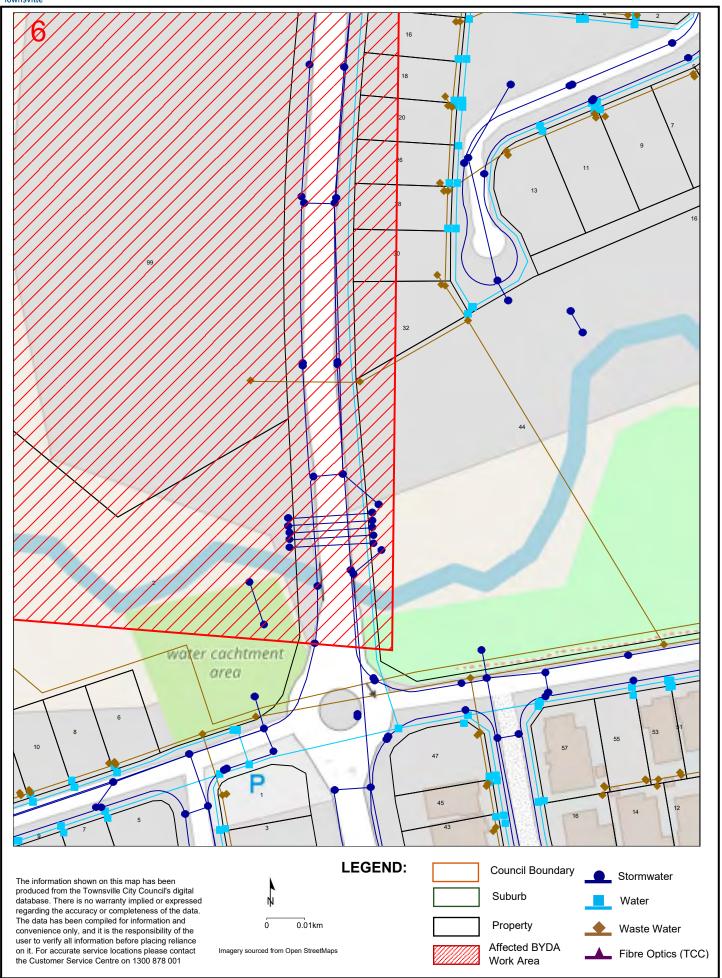PROPOSED RETIREMENT LIVING DEVELOPMENT

99 HOGARTH DRIVE, BOHLE PLAINS RUBY DEVELOPMENTS PTY LTD

Project Number: S24-020

INDEX OF DRAWINGS

GENERAL DRAWINGS

S24-020-PG01 COVER SHEET

PRELIMINARY CIVIL DRAWINGS

S24-020-PC01 CIVIL NOTES & LEGEND S24-020-PC02 SITE PLAN S24-020-PC03 CATCHMENT PLAN S24-020-PC04 PRELIMINARY SERVICES PLAN 1 of 2 S24-020-PC05 PRELIMINARY SERVICES PLAN 2 of 2 S24-020-PC06 STORMWATER DETAILS

PRELIMINARY EARTHWORKS DRAWINGS

S24-020-PE01 PRELIMINARY EARTHWORKS PLAN S24-020-PE02 PRELIMINARY EARTHWORKS SECTIONS



LOCALITY PLAN

							DESIGNED S.C.M	
							DRAWN J.J.D	1
							CHECKED J.M.H	1
							APPROVED J.M.H]
							DATE JULY 2024	For and or WESTER
No.	DATE	REVISIONS	DES	DRN	СНК	APD	DOCUMENT CONTROL	



	BRISBANE E brisbane@westerapartne	T 07 3852 4333 rs.com.au	SUF BR
4	GOLD COAST E goldcoast@westerapartne	T 07 5571 1599 ers.com.au	PHO
S	SUNSHINE COAST E sunshinecoast@westerap		USE
RS	NORTHERN NSW E nsw@westerapartners.co		DRAV AND
_	CENTRAL VICTORIA	T 03 5441 0922	THE

SURVEYOR BRAZIER MOTTI PHONE 07 4772 1144	DATUM A.H.D. PSM 95569 R.L. 17.143
USE FIGURED DIMENSIONS ONLY. DO NOT SCALE, IF A D CHECK WITH THE PROJECT ENGINEER AND/OR SUPERV WORK FROM REDUCED SCALE DRAWINGS (A1-A3 SIZE P	ISING AUTHORITY. DO NO

PROPOSED RETIREMENT LIVING DEVELOPMENT

LOT 1002 ON SP340654 99 HOGARTH DRIVE, BOHLE PLAINS COVER SHEET

RUBY DEVELOPMENTS PTY LTD

DRAWING STATUS PRELIMINARY N.F.C RAWING NUMBER S24-020-PG01 SHEET NUMBER 01 of 01

GENERAL NOTES

- WESTERA PARTNERS HAS LIMITED CONTROL OR INPUT TO LOCAL GOVERNMENT OR OTHER LEGISLATED APPROVALS UNLESS SPECIFICALLY ENGAGED BY IT'S CLIENT. ANY CHANGES TO APPROVAL REQUIREMENTS (INCLUDING ORDERS FOR SUSPENSION OF WORKS ETC) SHOULD BE COMMUNICATED TO WESTERA PARTNERS AND ALL OTHER RELEVANT DESIGNERS TO ALLOW ASSESSMENT OF POTENTIAL RISKS AND ENSURE DESIGN AND SAFETY COMPLIANCE.
- ALL CONSTRUCTION AND MATERIALS SHALL BE IN ACCORDANCE WITH THE LOCAL AUTHORITIES STANDARD DRAWINGS & SPECIFICATIONS AND COMPLETED TO THE SATISFACTION OF THE SUPERINTENDENT AND LOCAL AUTHORITY.
- UNIFSS SPECIFIED OTHERWISE ALL MATERIALS AND WORK SHALL COMPLY WITH
- PRIOR TO THE COMMENCEMENT OF CONSTRUCTION THE CONTRACTOR MUST LOCATE ALL EXISTING SERVICES AND PROMPTLY PROVIDE THE LOCATION DATA TO THE DESIGN ENGINEER TO ASSESS IMPACTS ON THE DESIGN.
- ALL CONNECTIONS TO EXISTING SEWERS AND WATER MAINS ARE TO BE CONSTRUCTED BY THE LOCAL AUTHORITY OR AN APPROVED CONTRACTOR. THE CONTRACTOR IS TO ALLOW IN HIS CONTRACT SUM FOR THE COST OF ANY PROPOSED CONNECTIONS.
- ALL SEWERS ARE TO BE 150MM DIA. ILP.V.C. CLASS SNR RUBBER RING. JOINTED AND PROPERTY CONNECTIONS ARE TO BE 100MM DIA. U.P.V.C CLASS SN6 UNLESS NOTED OTHERWISE
- THE PAVEMENT DEPTHS SHOWN ARE PRELIMINARY ONLY AND ARE TO BE VERIEIFD. FOLLOWING SUB-SOIL TESTS OF THE SUB-GRADE MATERIA
- ALL ROOFWATER CONNECTIONS FROM KERB ADAPTERS ARE TO BE 100MM DIA CLASS SNIO AT A MIN GRADE OF 1.0% UNLESS SHOWN OTHERWISE. ROOFWATER CONNECTIONS FROM FIELD INLETS OR GULLY PITS ARE TO BE 150MM DIA CLASS SN8 AT A MIN GRADE OF 1.0% UNLESS NOTED OTHERWISE.
- ALL U.P.V.C. STORMWATER DRAINAGE PIPES ARE TO BE CLASS SN8 (U.N.O.)

ALL R.C. PIPES ARE TO BE CLASS 3 (U.N.O.)

< 9000 = USE SPIGOT AND SOCKET PIPES WITH RUBBER RING JOINTS
9000 < PIPES < 10500 = USE FLUSH JOINTED PIPES WITH EXTERNAL
ELASTOMERIC BAND
10500 < PIPES = USE FLUSH JOINTED PIPES WITH EXTERNAL
ELASTOMERIC BAND AND INTERNAL CEMENT MORTAR
JOINT

ALL F.R.C. PIPES ARE TO BE FRCPIPE+ CLASS 4 (U.N.O.) AND SHALL BE DUAL RUBBER RING JOINT WITH COLLAR. PIPES SHALL BE FROM 2250 TO 6000 ONLY.

POLYPROPYLENE/POLYETHYLENE STORMWATER PIPE MINIMUM CLASS SN8 (U.N.O.) SUBJECT TO ACCEPTANCE BY CERTIFYING ENGINEER AND LOCAL AUTHORITY. CONSTRUCTION AND EMBEDMENT TO BE IN ACCORDANCE WITH MANUFACTURERS SPECIFICATIONS.

- WATER PIPES SHALL BE
- WATER PIPES ARE TO BE SERIES 2 PN16 SN10 R.R.J.

 D.I.C.L. WATER PIPES ARE TO BE PN35 WITH ALL FITTINGS TO BE FUSION
 BONDED POLYMERIC COATED.

 PE WATER PIPES ARE TO BE PN16 SDR11 PE100. DN25 AND DN32 WATER
- SERVICES SHALL BE PE80B.
- ALL "AS CONSTRUCTED" INFORMATION IS TO BE RECORDED AS REQUIRED BY THE LOCAL AUTHORITY AND SUBMITTED TO THE SUPERINTENDENT IMMEDIATELY AFTER COMPLETION OF THE WORKS.
- G12 ALL ALLOTMENTS ARE TO BE GRADED AT A MINIMUM GRADE OF 1 IN 200.

CONCRETE NOTES

- ALL WORKMANSHIP AND MATERIALS SHALL BE IN ACCORDANCE WITH AS3600 CONCRETE STRUCTURES CODE AND THE REFERENCED STANDARDS THEREIN.
- THE CONCRETE STRENGTH GRADE AND THE COVER TO REINFORCEMENT FOR THE VARIOUS CONCRETE ELEMENTS SHALL BE AS LISTED BELOW:
 - CLIMATE ZONE: TROPICAL TEMPERATE ARID
 - LOCATION: COASTAL NEAR COASTAL INLAND

ELEMENT	EXPOSURE CLASSIFICATION	STRENGTH GRADE	MINIMUM COVER				
MANHOLES	B1	N32	40				
MANHOLES	C2	S50	65				
FIELD INLET PITS	B1	N32	40				
FIELD INLET PITS	C2	S50	65				
LIEADWALLC	B1	N32	40				
HEADWALLS	C2	S50	65				
INTERNAL ROADS	B1	N32	40				
KERB/CHANNEL	B1	N32	-				
FOOTPATHS	B1	N32	40				
DETAINING WALL DANIELS	B1	N32	30*				
RETAINING WALL PANELS	C2	S50	60*				
BORED PIERS	B1	N32	40				
DUNED FIENS	C2	S50	65				

*RIGID FORMWORK & INTENSE COMPACTION

- CONCRETE TO HAVE A MAXIMUM AGGREGATE SIZE OF 20mm WITH 80mm C3 MAXIMUM SLUMP, A WATER/CEMENT RATIO OF NOT GREATER THAN 0.65 AND A MAXIMUM FINAL BASIC DRYING SHRINKAGE STRAIN OF 800×10^{-6} UNLESS APPROVED OTHERWISE.
- NO ADDITIVES SHALL BE ADDED OF APPLIED TO THE CONCRETE MIX WITHOUT THE APPROVAL OF THE ENGINEER.

THE MAXIMUM PERMISSIBLE TRANSPORT TIME FOR CONCRETE BETWEEN BATCHING AND PLACEMENT ON SITE SHALL BE IN ACCORDANCE WITH THE FOLLOWING TABLE.

AMBIENT AIR	MAX. BATCHING TO
TEMPERATURE	PLACEMENT TIME
10° - 24°C 25° - 27°C 28° - 30°C 31° - 33°C 34° - 36°C 37°C+	120 MINUTES 90 MINUTES 60 MINUTES 45 MINUTES 30 MINUTES NO PLACEMENT OF CONCRETE UNIFSS CHUI ED WATER OR ICF IN MIX


- C6 ALL CONCRETE SHALL BE MECHANICALLY VIBRATED. VIBRATORS SHALL NOT BE USED TO SPREAD CONCRETE.
- ALL CONCRETE SHALL BE SAMPLED AND TESTED IN ACCORDANCE WITH AS1379 ADDPTING THE PROJECT ASSESSMENT METHOD FOR COMPRESSIVE STRENGTH AND SLUMP COMPLIANCE. THE RESULTS OF ALL TESTS SHALL BE PROMPTLY SUBMITTED TO THE ENGINEER FOR REVIEW.
- WHEN THE AIR TEMPERATURE EXCEEDS 30°C, ALIPHATIC ALCOHOL SHALL BE APPLIED O THE CONCRETE SURFACE OF SLABS IMMEDIATELY AFTER THE INITIAL SCREED AND
- CURING OF ALL CONCRETE SURFACES SHALL COMMENCE IMMEDIATELY AFTER COMPLETING CONCRETE FINISHING AND SHALL CONTINUE FOR 7 DAYS. CONTRACTOR TO CONFIRM METHOD OF CURING WITH ENGINEER PRIOR TO USE.
- C10 SIZES OF CONCRETE FLEMENTS DO NOT INCLUDE THICKNESS OF APPLIED FINISHES.
- C11 BEAM DEPTHS ARE WRITTEN FIRST AND INCLUDE SLAB THICKNESS, IF ANY.
- C12 NO HOLES, CHASES OR EMBEDDED ITEMS OTHER THAN THOSE SHOWN ON THE STRUCTURAL DRAWINGS SHALL BE MADE IN CONCRETE MEMBERS WITHOUT PRIOR APPROVAL OF THE ENGINEER. CONDUITS, PIPES ETC. SHALL NOT BE PLACED IN THE COVER THICKNESS OF THE CONCRETE.
- WHERE SERVICE PIPES PENETRATE CONCRETE ELEMENTS, PROVISION SHOULD BE C13 MADE TO ALLOW FOR MOVEMENT OF THE FLEMENT
- FORMWORK SHALL BE DESIGNED, CONSTRUCTED AND STRIPPED IN ACCORDANCE
- REINFORCEMENT IS REPRESENTED DIAGRAMMATICALLY AND NOT NECESSARILY SHOWN
- ALL REINFORCEMENT SHALL BE SECURELY SUPPORTED IN ITS CORRECT POSITION ON PLASTIC BAR CHAIRS, GENERALLY AT NOT GREATER THAN 800mm CENTRES IN BOTH DIRECTIONS.
- WELDING AND HEATING OF REINFORCEMENT SHALL NOT BE PERMITTED WITHOUT APPROVAL OF THE ENGINEER.
- ALL STEEL REINFORCEMENT IN CONCRETE ELEMENTS SHALL BE INSPECTED BY THE C18 ENGINEER AND PASSED PRIOR TO POURING OF ANY CONCRETE.
- LAP REINFORCEMENT ONLY AT LOCATIONS SHOWN ON THE DRAWINGS OR AS C19 APPROVED BY THE ENGINEER
- SLAB FABRIC SHALL BE LAPPED ONE FULL PANEL OF FABRIC PLUS 50mm C20 SO THAT THE TWO OUTERMOST TRANSVERSE WIRES OF ONE SHEET OVERLAP THE TWO OUTERMOST TRANSVERSE WIRES OF THE SHEET BEING LAPPED BY 50mm.
- BAR REINFORCEMENT SHALL BE LAPPED IN ACCORDANCE WITH THE

TYPICAL BAR REINFORCEMENT LAP LENGTHS							
BAR LAP LENGTH UNO HORIZONTAL BARS WITH GREATER THAN 300mm of CONCRETE CAST BELOW THEM							
N12	550	750					
N16	800	1100					
N20	1100	1400					
N24	1250	1600					
N28	1400	1800					
N32	1600	2100					
N36	2000	2500					


WHERE LAPS ARE SHOWN ON THE DRAWINGS THE ABOVE LAP LENGTHS SHALL BE ADD'TED UNLESS NOTED OTHERWISE. WHERE BARS OF DIFFERENT DIAMETER ARE SHOWN LAPPED, ADOPT THE LAP LENGTH APPROPRIATE TO THE SMALLER


A VAPOUR BARRIER OF 0.2mm (200um) MINIMUM THICK POLYTHENE SHEETING SHALL BE PLACED BENEATH SLABS ON GROUND UNLESS NOTED OTHERWISE.

LEGEND

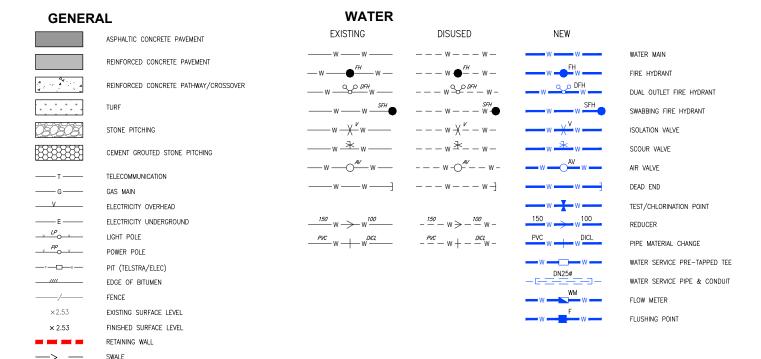

STORMWATER DRAINAGE

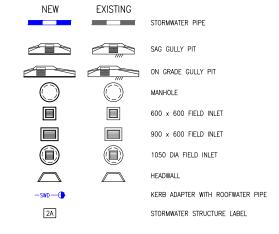

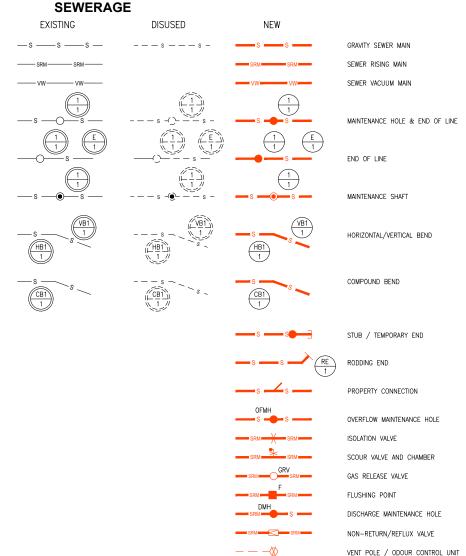

DESIGNED S.C.M	No.	DATE	REVISIONS	DES	DRN	СНК	APD	DOCUMENT CONTROL	Ι
DRAWN J.J.D CHECKED J.M.H								DATE JULY 2024	Fo W
DRAWN J.J.D								APPROVED J.M.H	
								CHECKED J.M.H	
DESIGNED S.C.M								DRAWN J.J.D	
Temperary Control								DESIGNED S.C.M	Γ



BRISBANE E brisbane@westerapartne	T 07 3852 4333 rs.com.au	SUR BR
GOLD COAST E goldcoast@westerapartne	T 07 5571 1599 ers.com.au	PHO
SUNSHINE COAST E sunshinecoast@westerap		USE F
NORTHERN NSW E nsw@westerapartners.co		DRAW AND U
CENTRAL VICTORIA	T 03 5441 0922	THE B

SURVEYOR	DATUM A.H.D.
BRAZIER MOTTI PHONE 07 4772 1144	PSM 95569 R.L. 17.143
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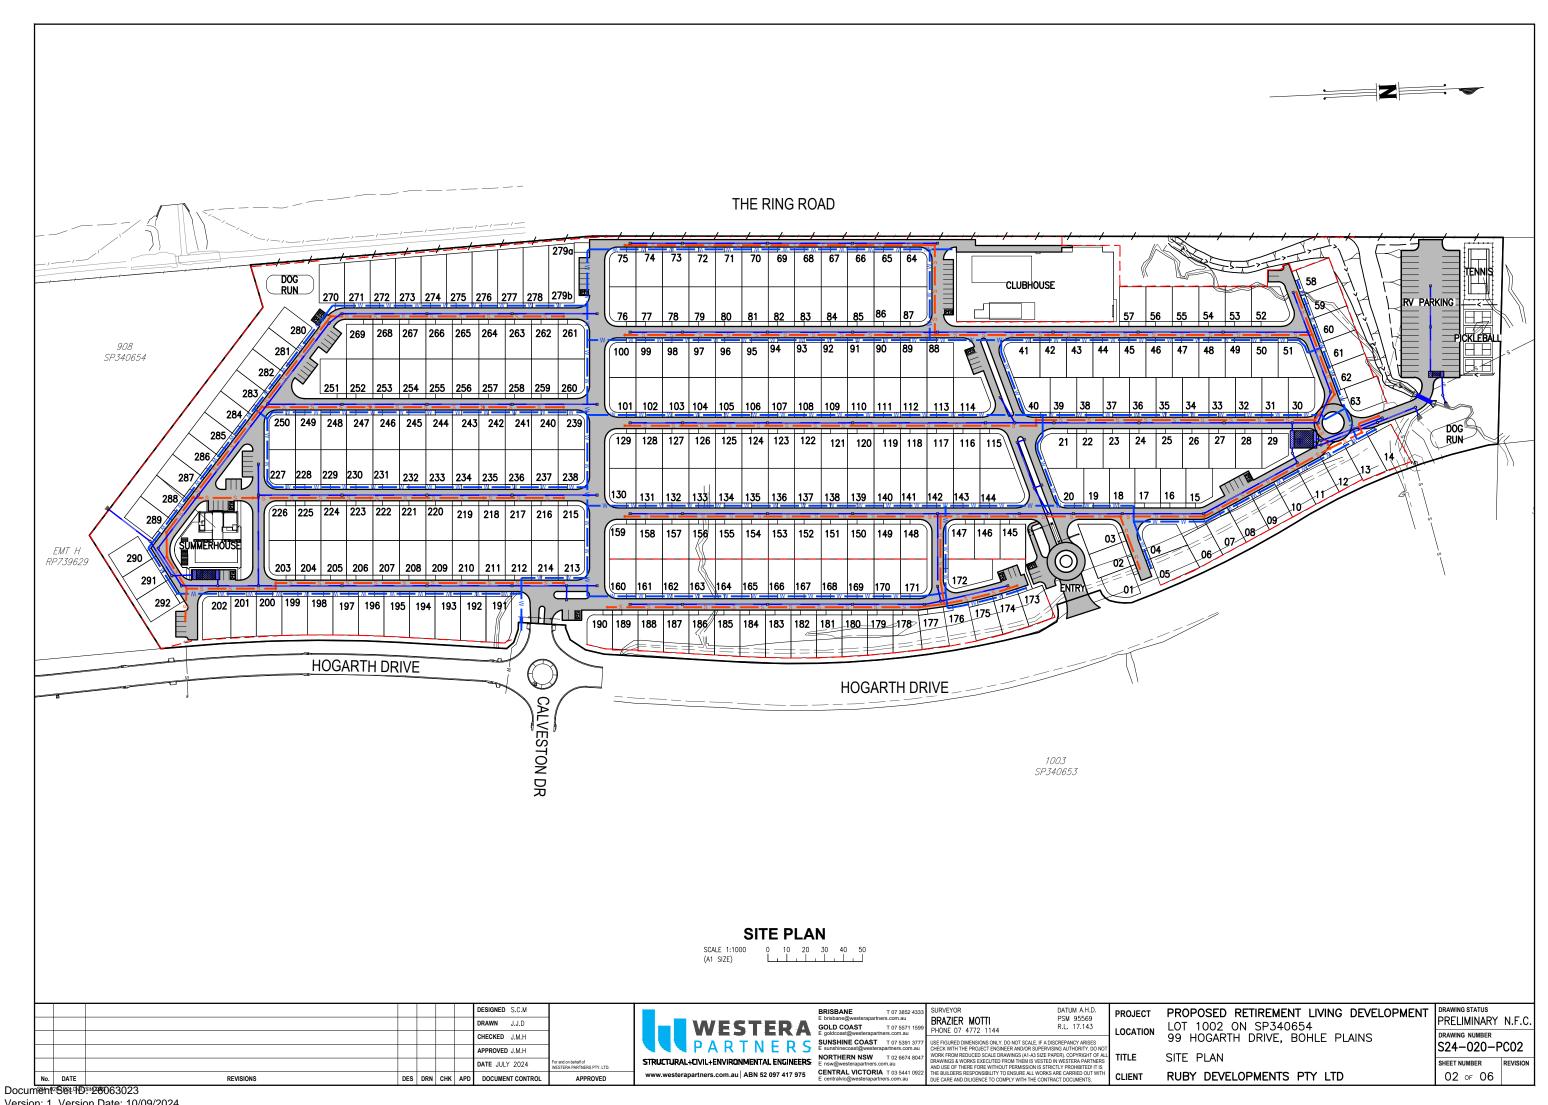
PROJECT LOCATION TITLE


CLIENT


PROPOSED RETIREMENT LIVING DEVELOPMENT LOT 1002 ON SP340654 99 HOGARTH DRIVE, BOHLE PLAINS CIVIL NOTES AND LEGEND


RUBY DEVELOPMENTS PTY LTD


DRAWING STATUS PRELIMINARY N.F.C. DRAWING NUMBER S24-020-PC01 SHEET NUMBER 01 of 06



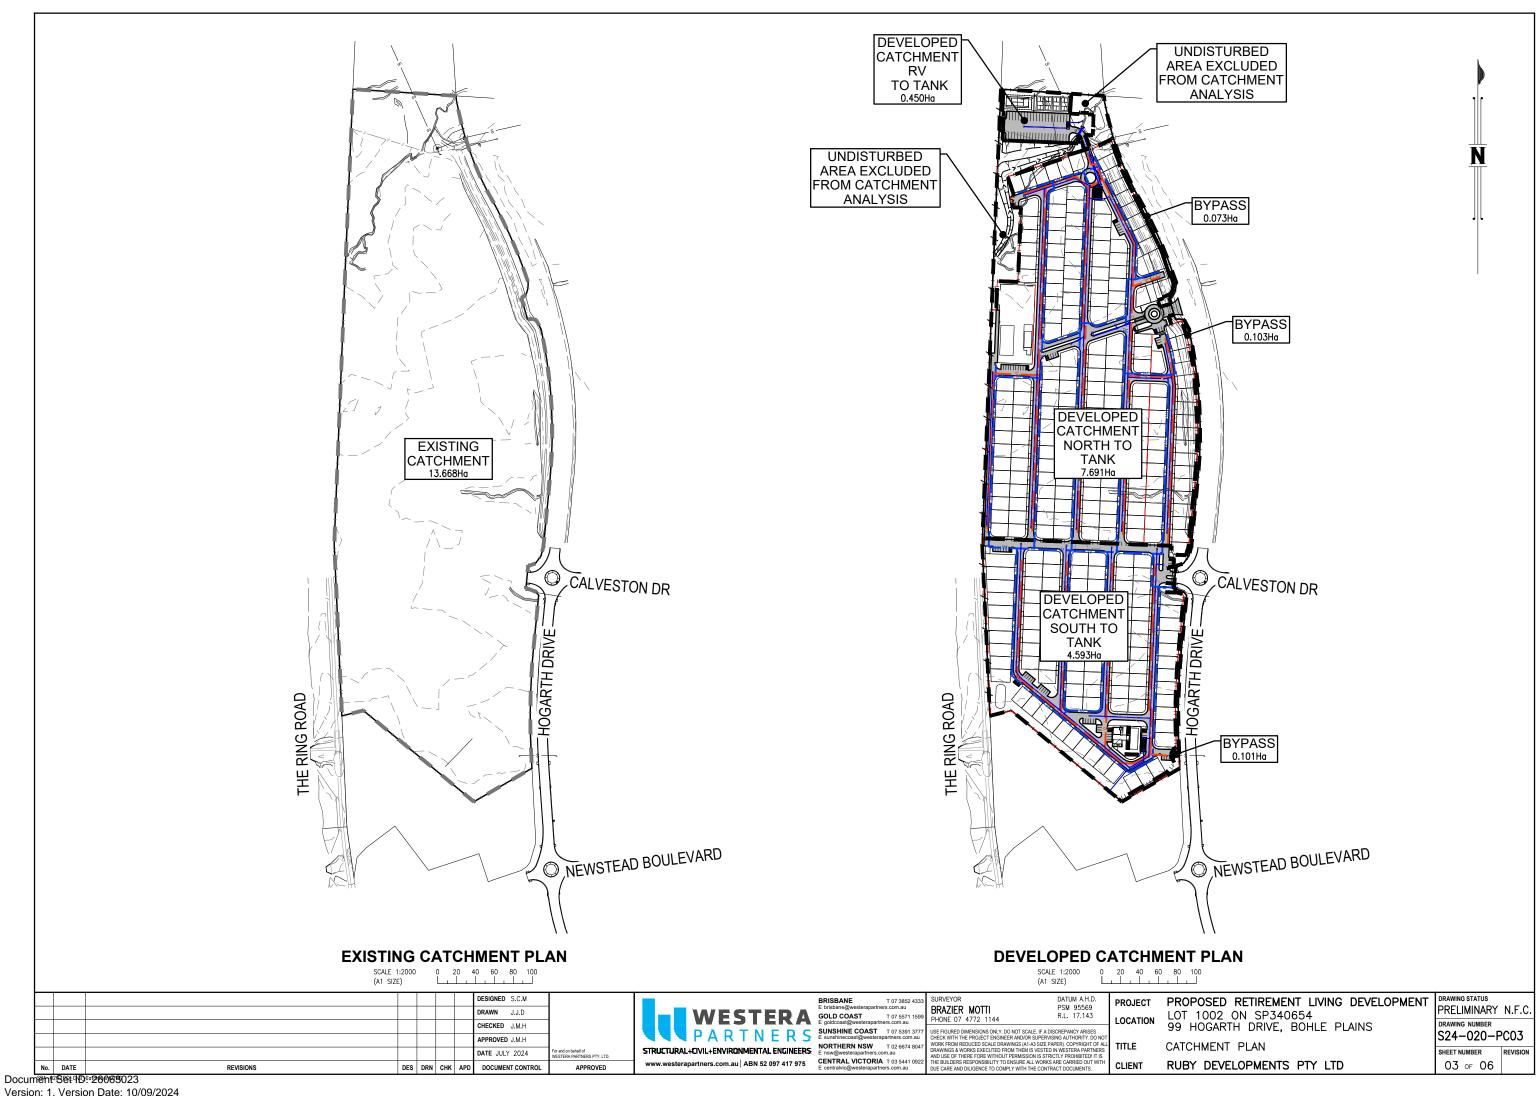


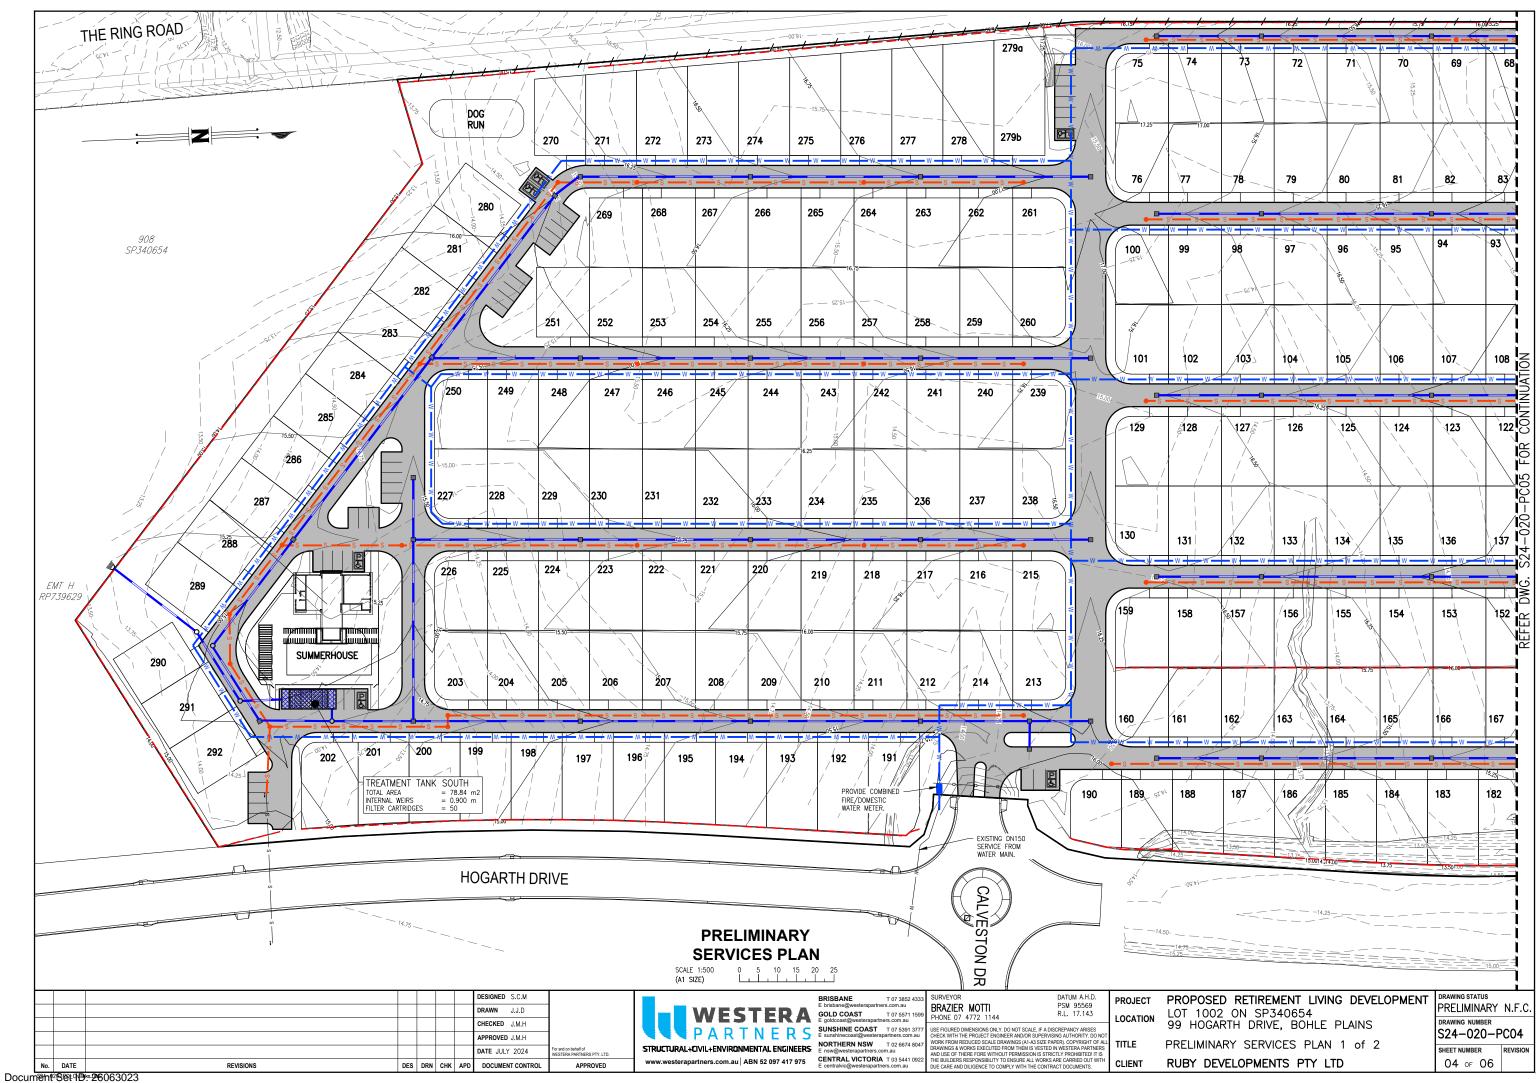


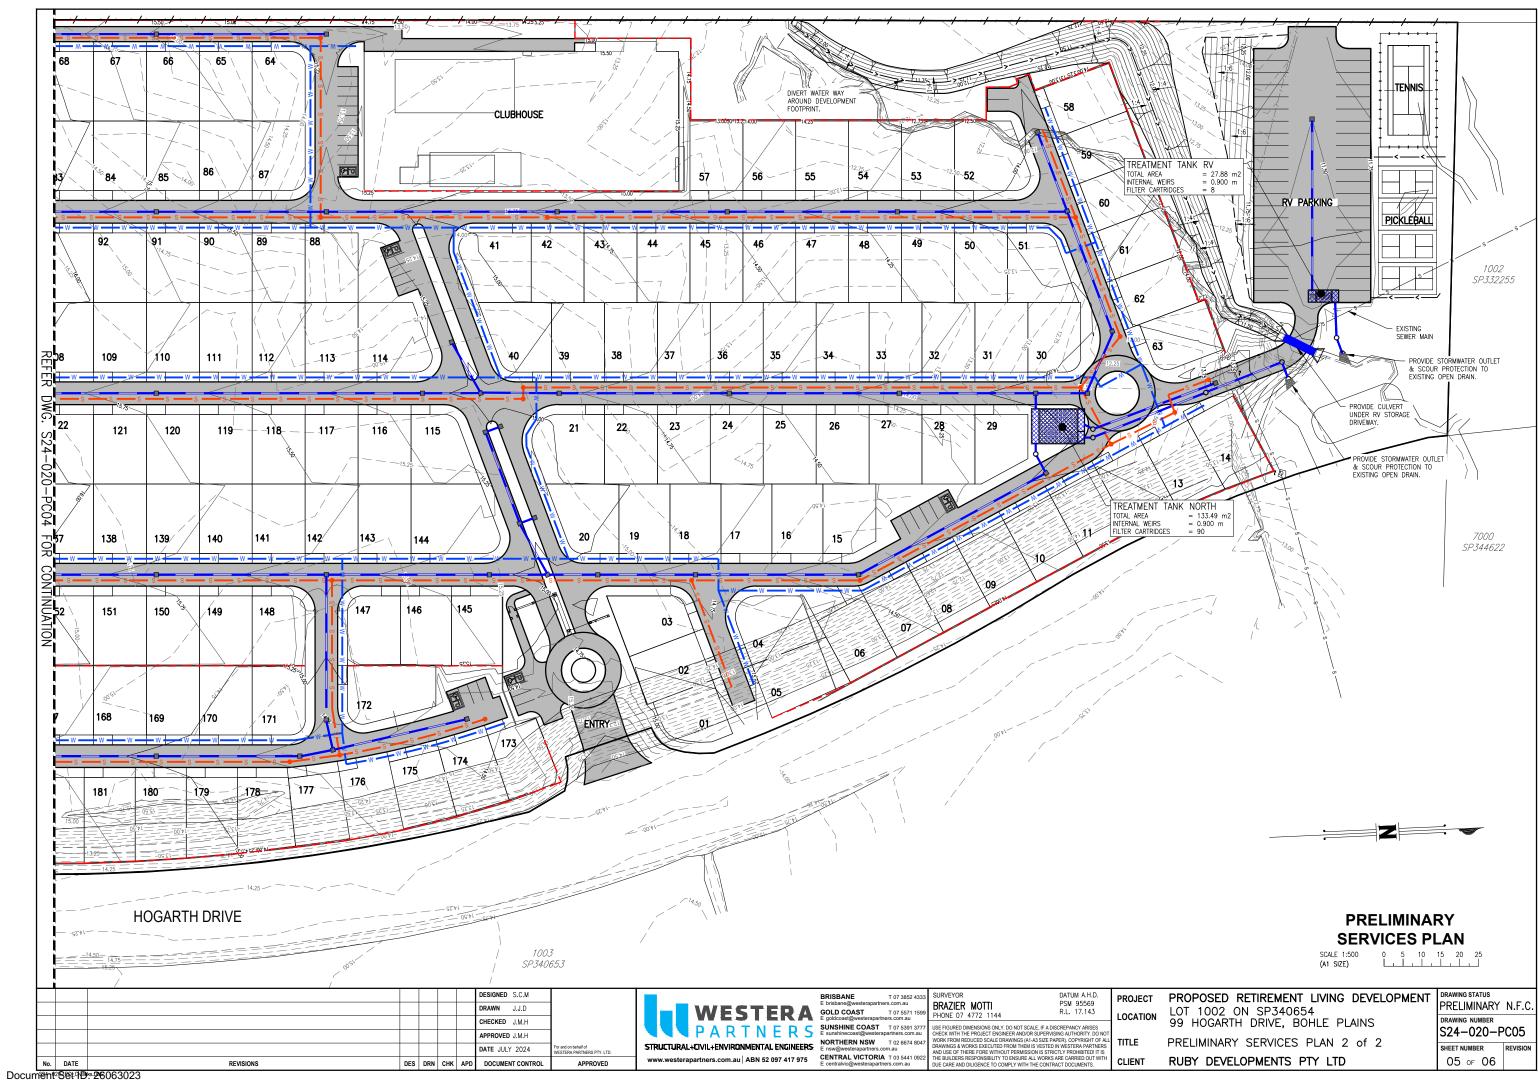

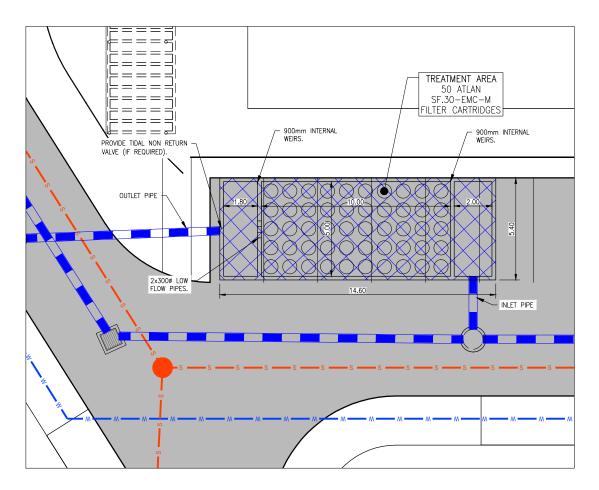

SOUTH TREATMENT TANK SCALE 1:100

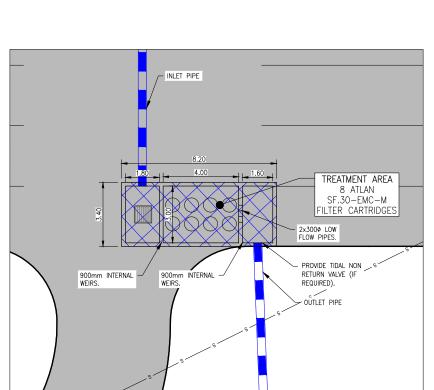

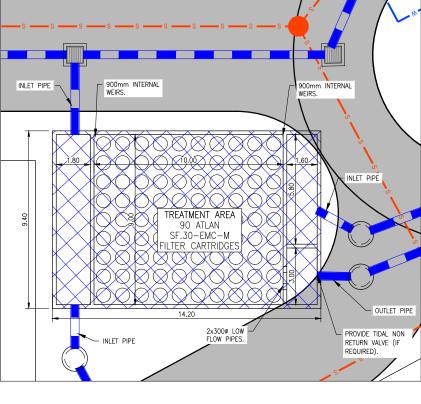

NORTH TREATMENT TANK

(A1 SIZE)

RV PARKING TREATMENT TANK SCALE 1:100 0 1 2 3 4 5 (A1 SIZE)

DESIGNED S.C.M DRAWN J.J.D	No.	DATE	REVISIONS	DES	DRN	СНК	APD	DOCUMENT CONTROL	APPROVED
DRAWN J.J.D CHECKED J.M.H									
DRAWN J.J.D								APPROVED J.M.H	
								CHECKED J.M.H	
DESIGNED S.C.M								DRAWN J.J.D	
								DESIGNED S.C.M	

WESTER! PARTNER STRUCTURAL+CIVIL+ENVIRONMENTAL ENGINEER www.westerapartners.com.au | ABN 52 097 417 975 CENTRAL VICTORIA T 03 5441 0 E centralvic@westerapartners.com.au

_	BRISBANE E brisbane@westerapartner	T 07 3852 4333 s.com.au	
4	GOLD COAST E goldcoast@westerapartne	T 07 5571 1599 ers.com.au	L
S	SUNSHINE COAST E sunshinecoast@westerap	T 07 5391 3777 artners.com.au	
RS	NORTHERN NSW E nsw@westerapartners.com		
5	CENTRAL VICTORIA	T 03 5441 0922	ı

333 599	SURVEYOR BRAZIER MOTTI PHONE 07 4772 1144	DATUM A.H.D. PSM 95569 R.L. 17.143
777 au 047 922	USE FIGURED DIMENSIONS ONLY. DO NOT SCALE, IF A CHECK WITH THE PROJECT ENDINEES AND/IONS SUPER-WORK FROM REDUCED SCALE DRAWINGS (A1-45 SIZE DRAWINGS AWORKS SECULTED FROM THEM IS VESTI AND USE OF THERE FORE WITHOUT PERMISSION IS STIFLE BUILDERS RESPONSIBILITY TO ENSURE ALL WORD DILE CARE AND DUE CARE AND DUELONE TO COMPLY WITH THE CON	IVISING AUTHORITY. DO NOT PAPER). COPYRIGHT OF ALI ED IN WESTERA PARTNERS FRICTLY PROHIBITED! IT IS KS ARE CARRIED OUT WITH

PROJECT LOCATION


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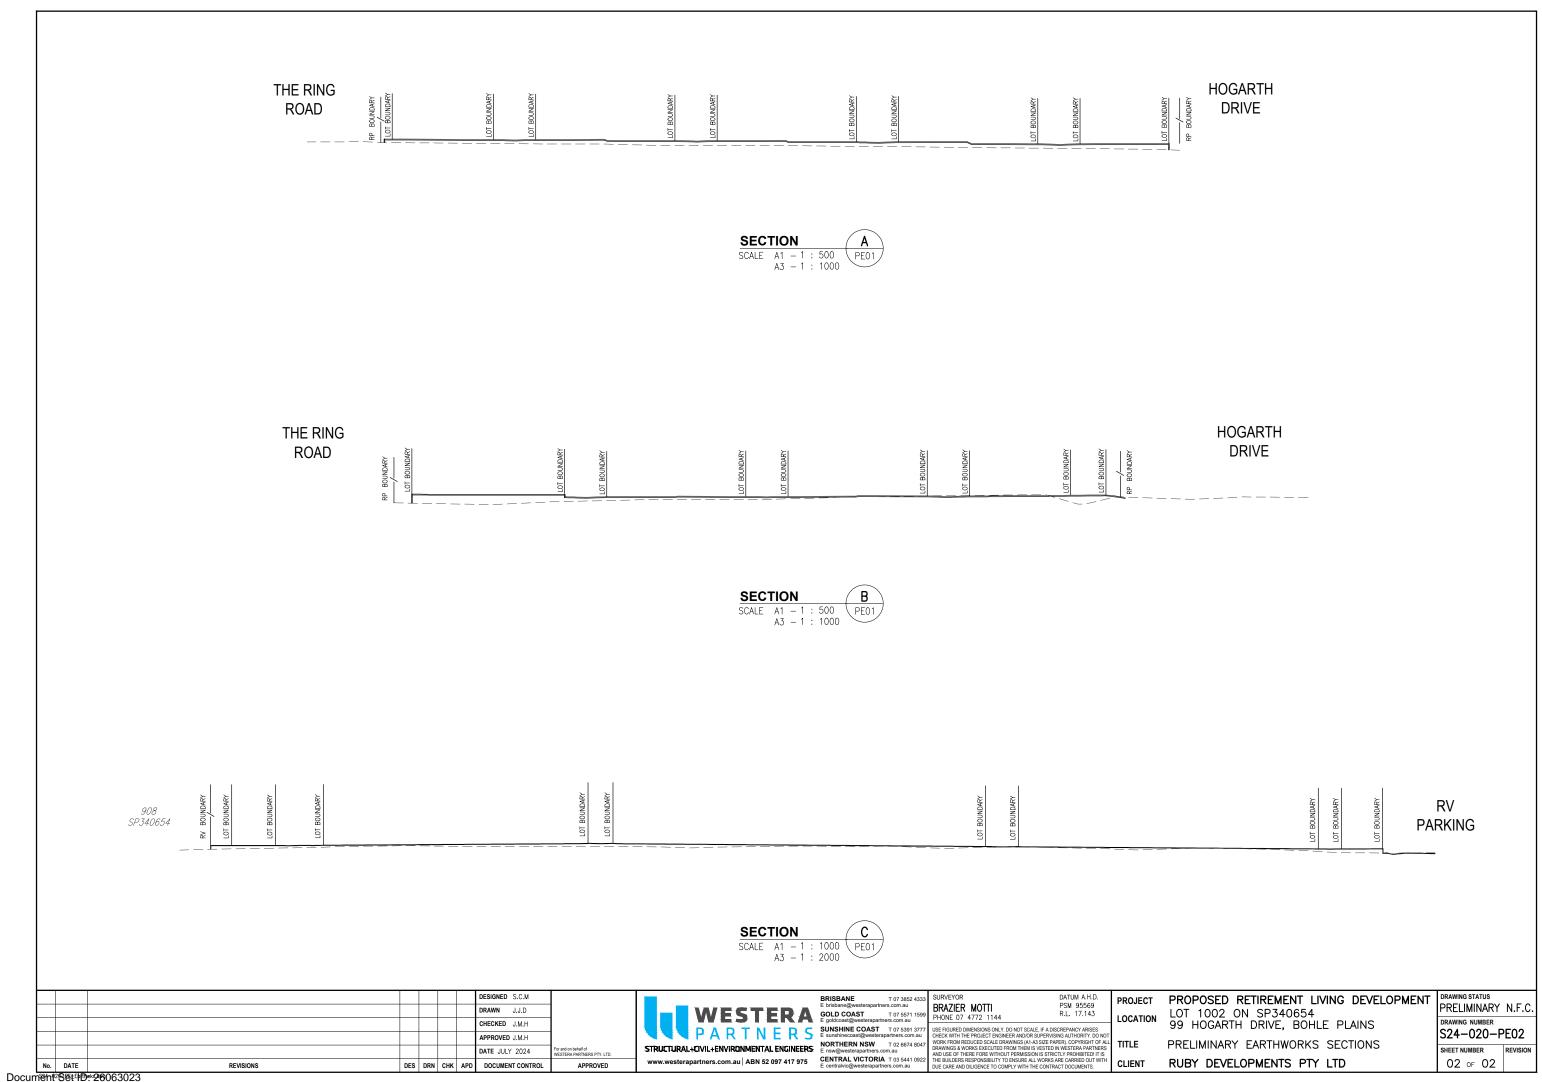
CLIENT

PROPOSED RETIREMENT LIVING DEVELOPMENT LOT 1002 ON SP340654 99 HOGARTH DRIVE, BOHLE PLAINS STORMWATER DETAILS

RUBY DEVELOPMENTS PTY LTD

DRAWING STATUS PRELIMINARY N.F.C. DRAWING NUMBER S24-020-PC06 SHEET NUMBER 06 OF 06




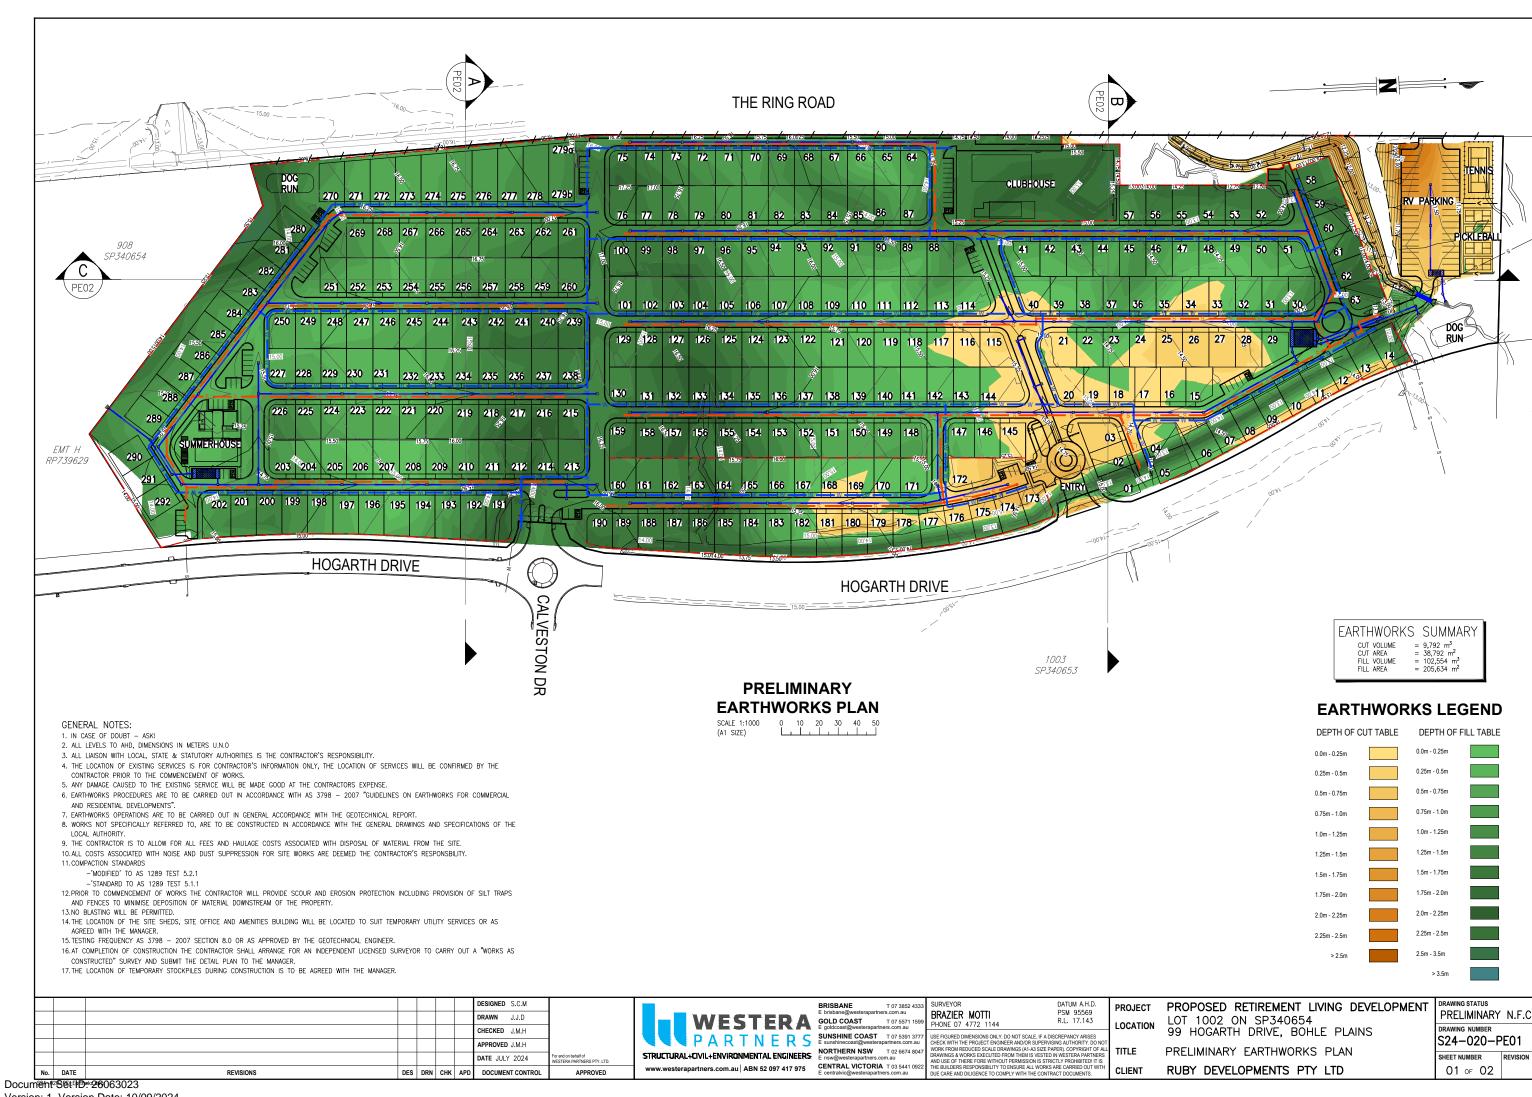




Appendix D - Survey and Architectural Drawing



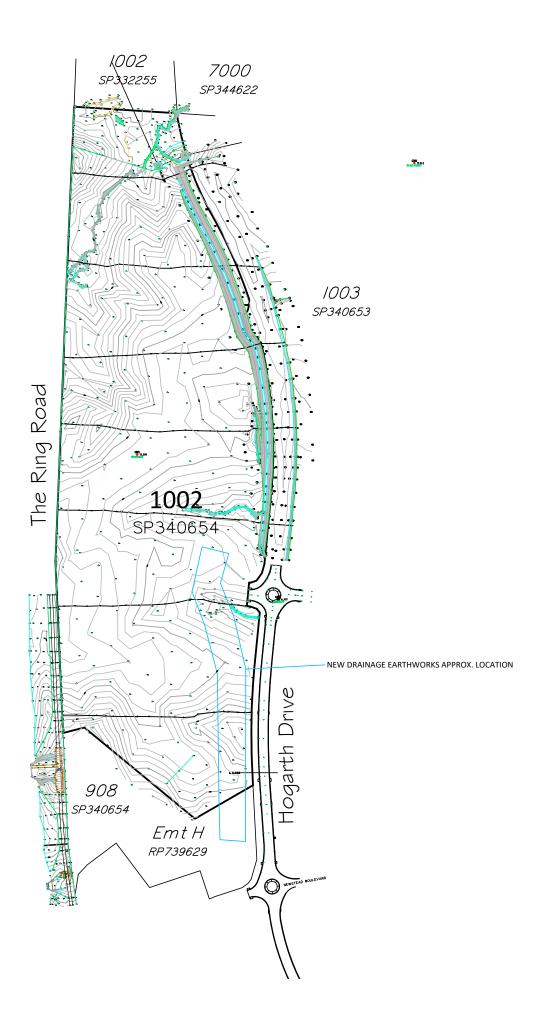

Note:

This plan represents a combination of surveys undertaken 06/08/2020, 17/05/2021 and 18/06/2024. A combined surface model has been created from these different surveys and is subject to survey. All levels to be verified prior to commencement of any design

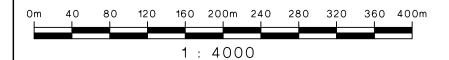

The title boundaries as shown hereon were not marked at the time of survey and have been determined by plan dimensions only and not by field survey. No attempt has been made to locate any services. Prior to any demolition, excavation or construction on the site, the relevant authority should be contacted for possible location of further underground services and detailed locations of all services.

Level Datum: AHD Der.

B.M. Used: PSM95569 RL.17.143

Coordinate Projection: MGA Zone 55

Coordinate Datum: MGA94

Origin of Coordinates: PSM131662 E: 468140.991
Meridian: MGA Zone 55 N: 7865023.405

Map Reference:

Contour Interval:

Job No: 43793/002-01

File No: 43793_001B.dwg

Surveyed by: BM

Drawn: MJM

Approved:

RUBY DEVELOPMENTS PTY LTD

roject:

SKETCH PLAN OF COMBINED SURVEYS
LOT 1002 ON SP340654
HARRIS CROSSING

Local Authority: Townsville City Council


Locality: Bohle Plains

Date: 10	th July,				
Sheet	1	of	2	Sheets	
Scale: 1	:4000				А3
Plan No: 43793/0				/001	В

braziermotti.com.au

SURVEYING TOWNPLANNING PROJECTMANAGEMENT MAPPING&GIS



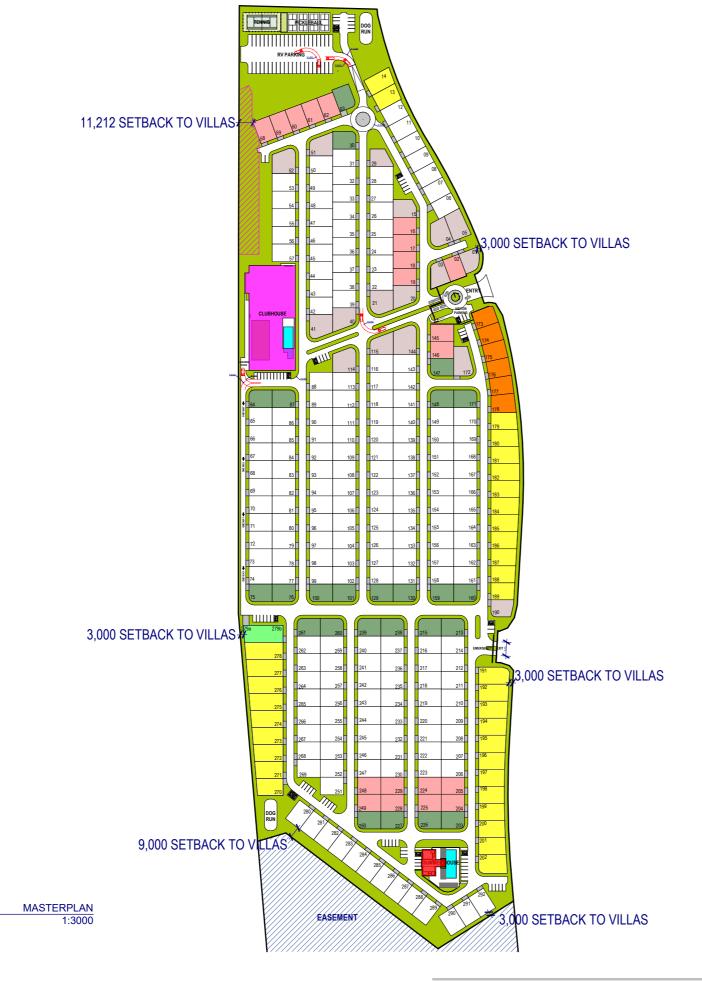

YIELD

TOTAL NUMBER OF LOTS	292					
LOT SIZE						
14.0m x 21.0m STANDARD LOTS	191					
13.5m x 21.0m STANDARD LOTS	20					
13.5m x 21.0m+ VARIOUS LENGTH LOTS	34					
14m x 21.0m CORNER VILLA LOTS	25					
13.5m x 21.0m SPLAYED LOTS	6					
SPECIAL LOTS	17					
DUPLEX LOT (279a & 279b)	1					

STATISTICS

VISITOR CAR PARKING	90
RV PARKING	42
SITE AREA	136,728 m2
SITE COVER	%
TOTAL SITE COVER (LOTS + ROADS + FACILITIES)	%
OPEN SPACE (MIN.DIMENSION OF 2m)	31,700 m ²
SITE PERIMETER	1.778 m ²

AREAS

CLUB HOUSE (UNDER ROOF)	3117m ²
SUMMER HOUSE (INCL. WORKSHOP)	970m ²
DOG RUN STRUCTURES	250m ²
ENTRY STATEMENT & GATE HOUSE	20m ²
TENNIS COURT	450m ²
PICKLEBALL COURT	495m ²

FOR APPROVAL NOT FOR CONSTRUCTION



)	Please rokes and verify all dimensions prior to construction. All measurement is an infillinetial surface shown offenesis do not citize from the disease of saving any of all delayers, documents and dismigra are the property of Soils Estado Pry UE You ben'ty present post will not so vary given, documents and dismigra are the property of Soils Estado Pry UE You ben'ty present cours the note designs, documents or dismigra (is any part theered) without the prior without not be consistent from Soils Estado Pry UE Should any Sevent cours the notes shall be on you to prove you have not been to bease to trace of the consistent from Soils Estado Pry UE Should any Sevent cours the notes shall be on you to prove you have not been to bease to trace of the consistent from the shall be all beginning and performance of the build.	
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PROJECT NO.	HOA23-19
STATUS	CONCEPT
CLIENT	GEMLIFE

GENERAL MASTERPLAN HARRIS CROSSING - MASTERPLAN LOT 908 & 1002 ON SP340654 TOWNSVILLE, QLD

A3 PLOT DATE: DRAWING NO.

REVISION NO. REV F.2

SK-005





Appendix E - As-Constructed Information

HARRIS CROSSING - HOGARTH DRIVE EXTENSION PART B HERVEY RANGE ROAD, BOHLE PLAINS FOR MAIDMENT LAND PTY LTD



TOWNSVILLE EARTHMOVING DO HEREBY CERTIFY THAT THE WORKS SHOWN ON THE 'AS CONSTRUCTED' DRAWINGS HAVE BEEN CONSTRUCTED IN ACCORDANCE WITH THE DRAWINGS AND CONTRACT DOCUMENTS APPROVED BY COUNCIL FOR THE CONSTRUCTION OF THE PROJECT.

AUTHORISED DELEGATE DATE ...15/04/21

PREMISE DO HEREBY CERTIFY THAT THE WORKS AS SHOWN ON THE 'AS CONSTRUCTED' DRAWINGS REFLECT ANY CHANGES THAT WERE MADE DURING THE COURSE OF CONSTRUCTION.

SURVEY ORIGIN

AHD (DERIVED)
PSM152062
E: 86443.441
N: 67956.110
ORIGIN OF COORDINATES

REAL PROPERTY DESCRIPTION
LOT 1001 ON SP300778 & LOT 1003 ON SP278255

HOGARTH DRIVE EXTENSION - PART B SITE AREA 0.90Ha **BUILT WITH STAGE 25 AND 26** LOCALITY PLAN

DRAWING SCHEDULE				
Sheet Number	Sheet Title			
195	LOCALITY PLAN AND DRAWING SCHEDULE			
196	ROADWORKS AND STORMWATER DRAINAGE PLAN			
197	HOGARTH DRIVE LONGITUDINAL SECTION			
198	HOGARTH DRIVE TYPICAL CROSS SECTIONS			
199	ROADWORKS AND LINEMARKING DETAILS PLAN			
200	Q2 STORMWATER LONGITUDINAL SECTION			
201	Q2 AND Q5 STORMWATER LONGITUDINAL SECTION			
202	CULVERT DETAIL PLAN			
203	WATER AND SEWERAGE RETICULATION PLAN			






				Level Datum: A.H.D		
No.	Date	Details	Check	B.M. Used:PSM200738 RL:13.973		
Α	15.04.21	AS-CONSTRUCTED ISSUE	GEO	Coordinate Projection: Plane Rectan	gular	
				Coordinate Datum: Arbitrary		
				Origin of Coordinates: -	E:	-
				Meridian: MGA94 (Zone 55)	N:	-
				Map Reference: 8259-31233		
				Contour Interval:	Surveye	d by:BM
				Job No: 40450-098-01	Drawn:	MJM
		* ID: 26062022		File No: 40540_195A.dwg	Approve	d:

Document Set ID: 26063023 Version: 1, Version Date: 10/09/2024 Client: MAIDMENT LAND PTY LTD


Project:
HOGARTH DRIVE EXTENSION - PART B
HOGARTH DRIVE - HERVEY RANGE ROAD
LOCALITY PLAN AND DRAWING SCHEDULE


Local Authority: Townsville City Council
Locality: Bohle Plains

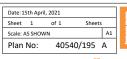






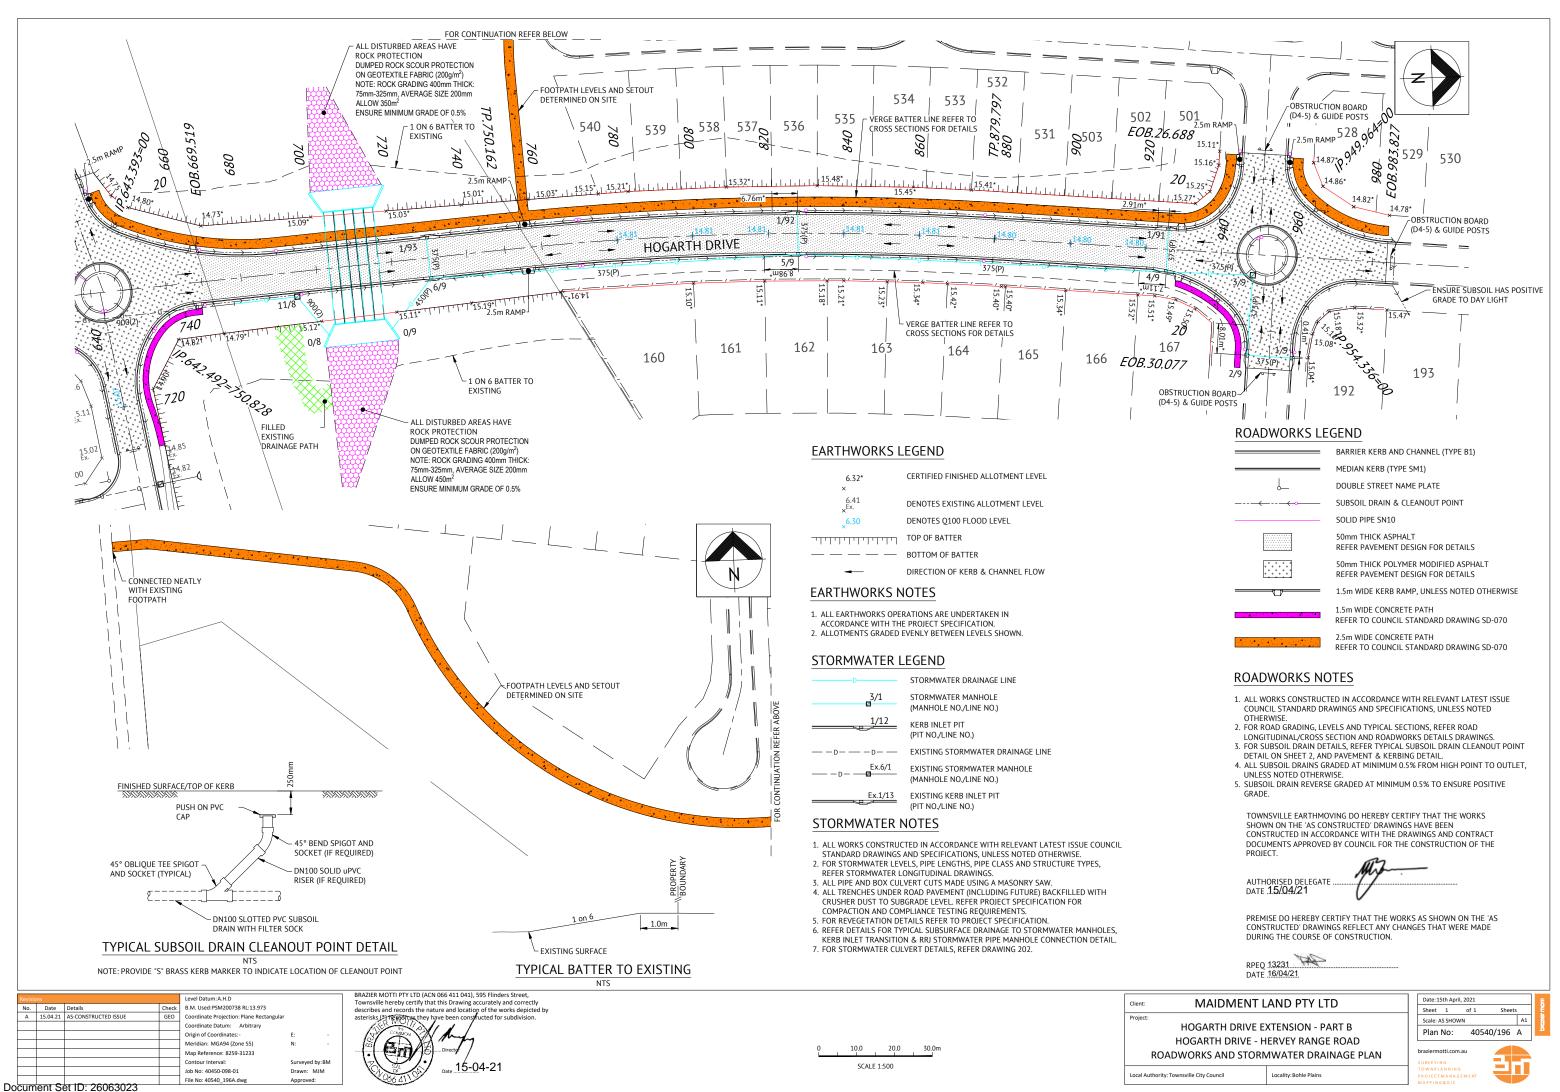

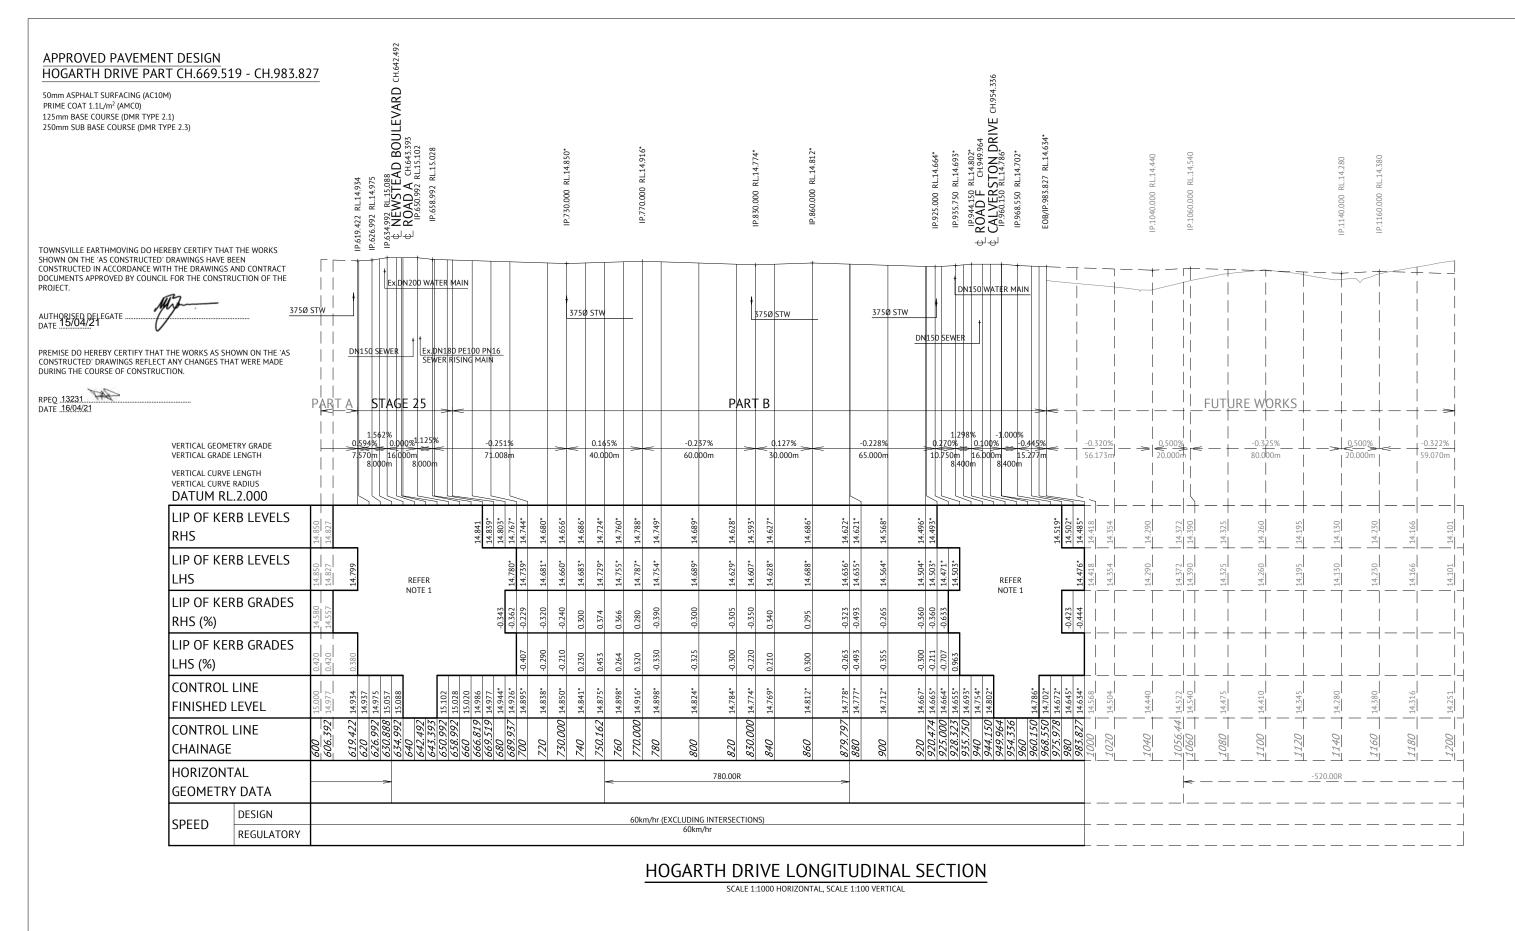

ROAD LONGITUDINAL SECTION NOTES

- 1. FOR LEVEL INFORMATION REFER ROADWORKS DETAILS PLAN.
- 2. FOR TYPICAL SECTIONS REFER TO RELEVANT ROAD CROSS SECTION PLAN.

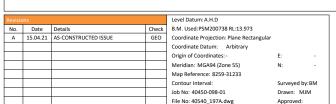

BRAZIER MOTTI PTY LTD (ACN 066 411 041), 595 Flinders Street,
Townsville hereby certify that this Drawing accurately and correctly
describes and records the nature and location of the worsk depicted by
asterisks (*) bereen as they have been constructed for subdivision.

Director

Date 15-04-21

Client: MAIDMENT LAND PTY LTD

Project:
HOGARTH DRIVE EXTENSION - PART B
HOGARTH DRIVE - HERVEY RANGE ROAD
HOGARTH DRIVE LONGITUDINAL SECTION

Local Authority: Townsville City Council Locality: Boble Plains

SCALE 1:1000

40.0

URVEYING
OWNPLANNING
ROJECT MANAGEMENT


20.0

PROJECTM
MAPPING

2.0

SCALE 1:100

4.0

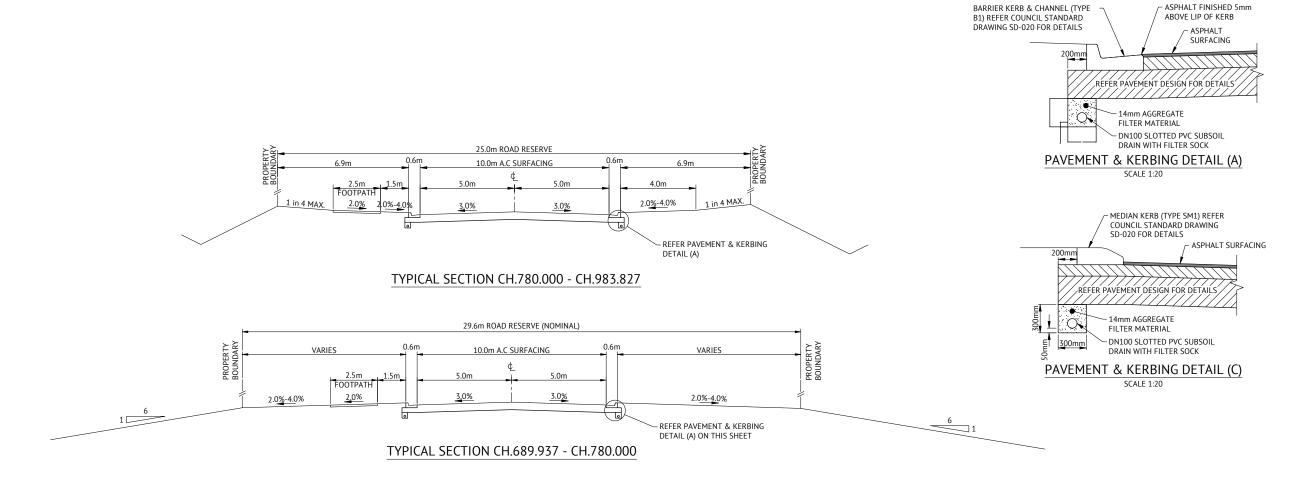

HOGARTH DRIVE CROSS SECTIONS

SCALE 1:100

TOWNSVILLE EARTHMOVING DO HEREBY CERTIFY THAT THE WORKS SHOWN ON THE 'AS CONSTRUCTED' DRAWINGS HAVE BEEN CONSTRUCTED IN ACCORDANCE WITH THE DRAWINGS AND CONTRACT DOCUMENTS APPROVED BY COUNCIL FOR THE CONSTRUCTION OF THE

AUTHORISED DELEGATE . DATE ..1.5/.0.4/21


PREMISE DO HEREBY CERTIFY THAT THE WORKS AS SHOWN ON THE 'AS CONSTRUCTED' DRAWINGS REFLECT ANY CHANGES THAT WERE MADE DURING THE COURSE OF CONSTRUCTION.

RPEQ 13231 DATE 16/04/21

Revisio	ins			Level Datum: A.H.D		
No.	Date	Details	Check	B.M. Used:PSM200738 RL:13.973		
Α	15.04.21	AS-CONSTRUCTED ISSUE	GEO	Coordinate Projection: Plane Rectang	ular	
				Coordinate Datum: Arbitrary		
				Origin of Coordinates: -	E:	
				Meridian: MGA94 (Zone 55)	N:	
				Map Reference: 8259-31233		
				Contour Interval:	Surveyed	by:BM
				Job No: 40450-098-01	Drawn:	MJM
				File No: 40540 198A.dwg	Approve	d:

MAIDMENT LAND PTY LTD Project: HOGARTH DRIVE EXTENSION - PART B HOGARTH DRIVE - HERVEY RANGE ROAD HOGARTH DRIVE TYPICAL CROSS SECTIONS Local Authority: Townsville City Council Locality: Bohle Plains

Sheet 1 of 1 Scale: AS SHOWN Plan No: 40540/198 A

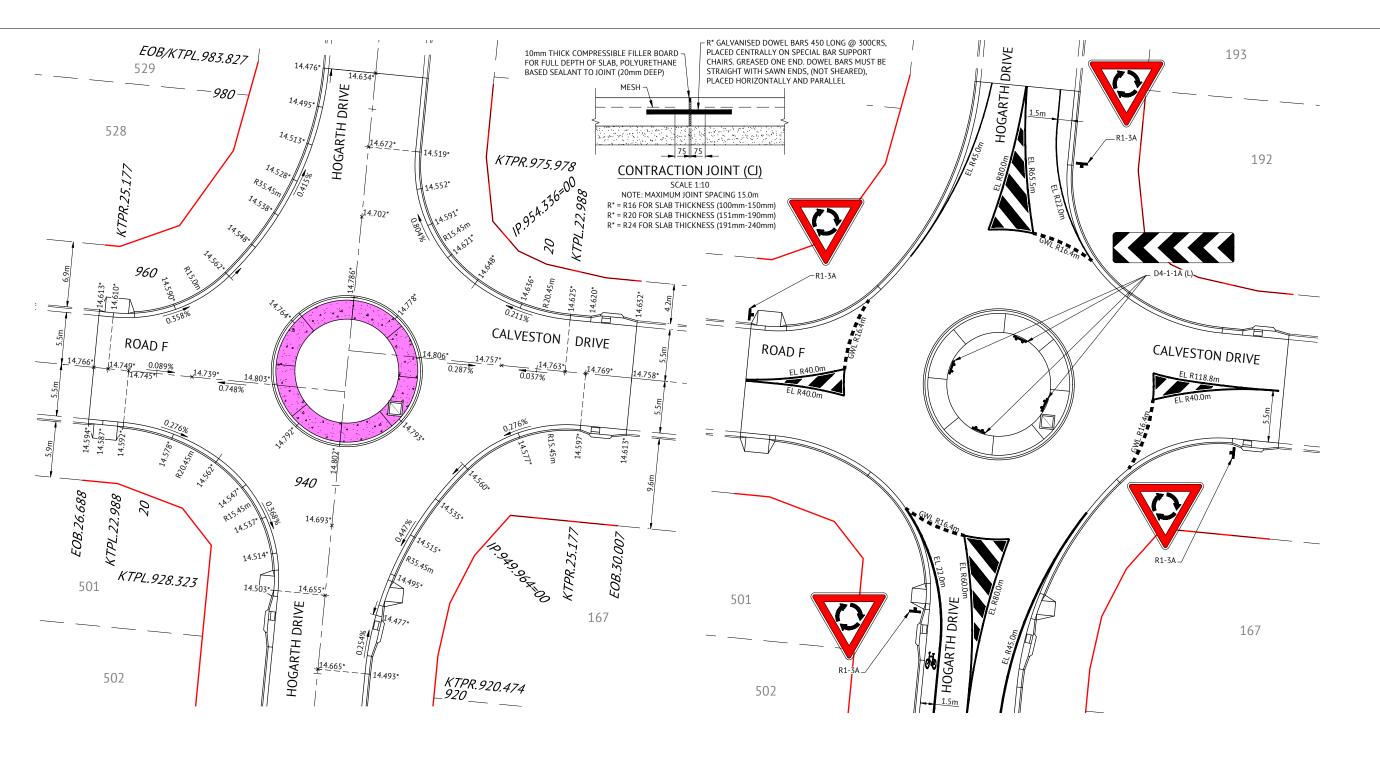


TOWNSVILLE EARTHMOVING DO HEREBY CERTIFY THAT THE WORKS SHOWN ON THE 'AS CONSTRUCTED' DRAWINGS HAVE BEEN CONSTRUCTED IN ACCORDANCE WITH THE DRAWINGS AND CONTRACT DOCUMENTS APPROVED BY COUNCIL FOR THE CONSTRUCTION OF THE PROJECT.

AUTHORISED DELEGATE DATE 15/04/21

PREMISE DO HEREBY CERTIFY THAT THE WORKS AS SHOWN ON THE 'AS CONSTRUCTED' DRAWINGS REFLECT ANY CHANGES THAT WERE MADE DURING THE COURSE OF CONSTRUCTION.



ROADWORKS DETAILS LEGEND

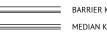

BARRIER KERB & CHANNEL (TYPE B1)


MEDIAN KERB (TYPE SM1)

ROUNDABOUT ANNULUS
REFER DETAIL THIS SHEET

ROADWORKS DETAILS NOTES

- ALL WORKS CONSTRUCTED IN ACCORDANCE WITH RELEVANT LATEST ISSUE COUNCIL STANDARD DRAWINGS AND SPECIFICATIONS, UNLESS NOTED OTHERWISE.
- ALL RADII, LEVEL INFORMATION IS TO LIP OF KERB UNLESS NOTED OTHERWISE.

LINEMARKING LEGEND

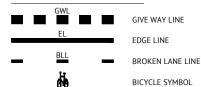

LINEMARKING NOTES

- 1. ALL LINEMARKING, SIGNAGE AND PLACEMENT OF RRPM'S IN ACCORDANCE WITH M.U.T.C.D.
- ALL LINEMARKING IS WHITE PAINT UNLESS NOTED OTHERWISE.

0		0.2	0.4	- 1	0.6m				
		SCA	LE 1:10						
0		0.5	1.0		1.5m				
	SCALE 1:25								
Ō		4.0	8.0		12.0m				
SCALE 1:200									

Revisio	ons			Level Datum: A.H.D	
No.	Date	Details	Check	B.M. Used:PSM200738 RL:13.973	
Α	15.04.21	AS-CONSTRUCTED ISSUE	GEO	Coordinate Projection: Plane Rectangular	
				Coordinate Datum: Arbitrary	
				Origin of Coordinates: -	E:
				Meridian: MGA94 (Zone 55)	N:
				Map Reference: 8259-31233	
				Contour Interval:	Surveyed by
				lob No: 40450-098-01	Drawn: MII

BRAZIER MOTTI PTY LTD (ACN 066 411 041), 595 Flinders Street, Townsville hereby certify that this Drawing accurately and correctly describes and records the natural opation of the works depicted by asterists of persons they have deep constructed for subdivision.

Director

15-04-21

Date

Client: MAIDMENT LAND PTY LTD


Project:
HOGARTH DRIVE EXTENSION - PART B
HOGARTH DRIVE - HERVEY RANGE ROAD
ROADWORKS AND LINEMARKING DETAILS PLAN


Local Authority: Townsville City Council Locality: Bohle Plains



braziermotti.com.au SURVEYING TOWNPLANNING PROJECTMANAGEMENT MAPPING&GIS



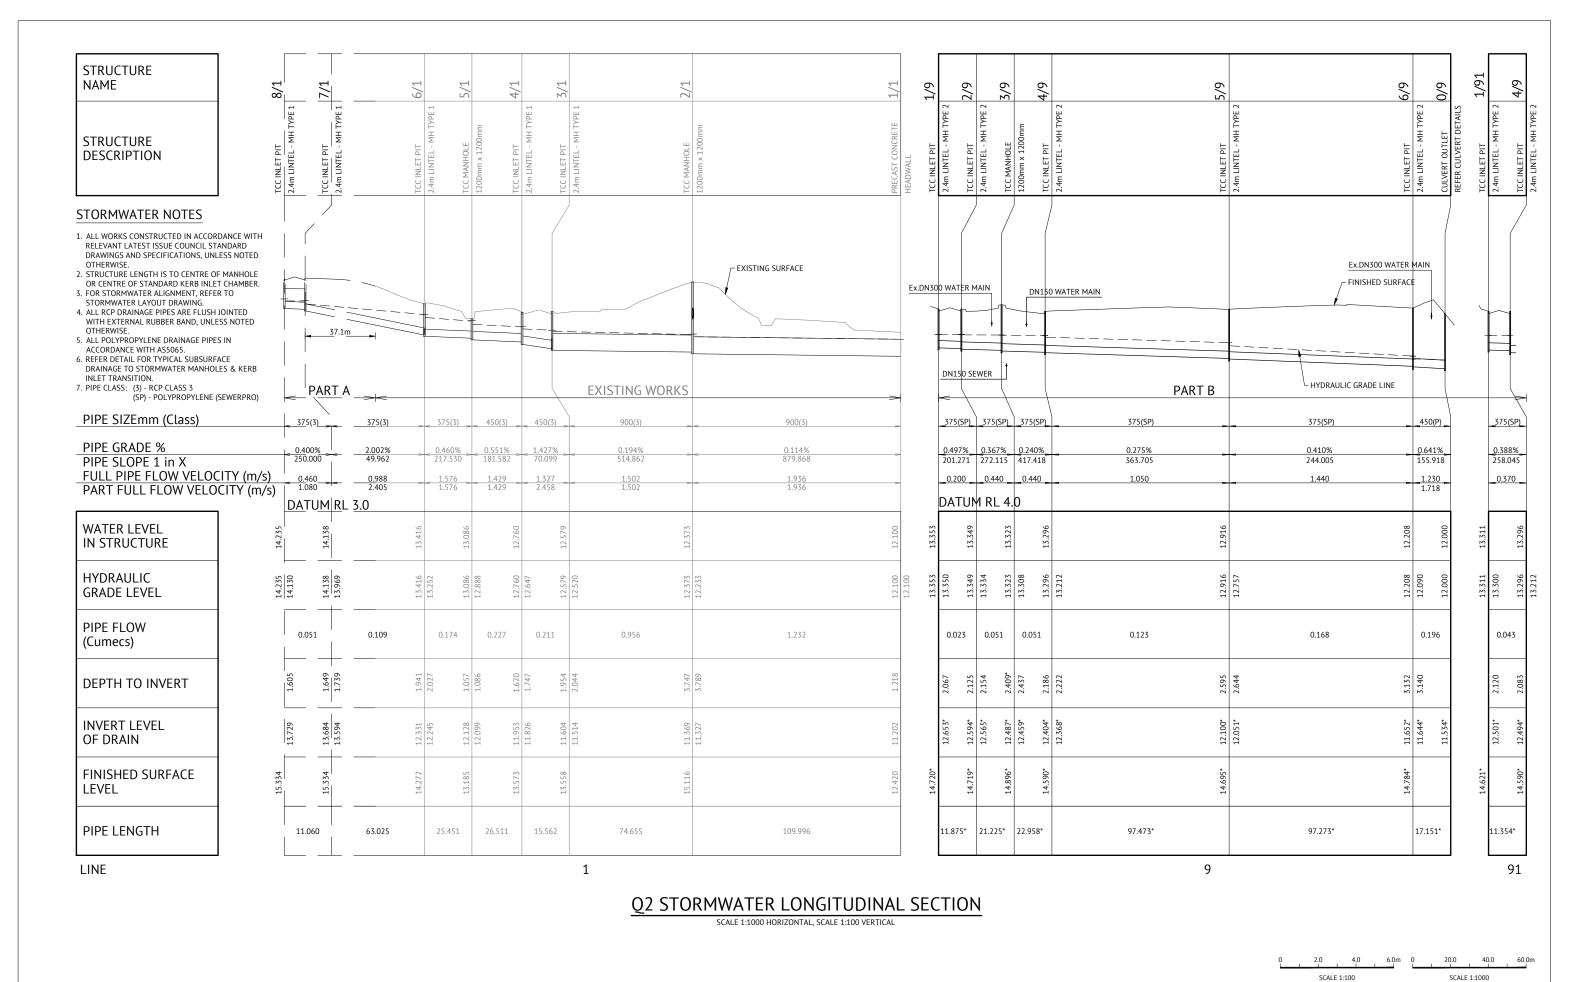

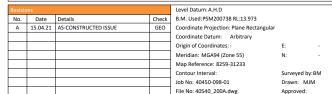

BRAZIER MOTTI PTY LTD (ACN 066 411 041), 595 Flinders Street. Townsville hereby certify that this Drawing accurately and correctly describes and records the nature and location of the works depicted by 15-04-21

PREMISE DO HEREBY CERTIFY THAT THE WORKS AS SHOWN ON THE 'AS CONSTRUCTED' DRAWINGS REFLECT ANY CHANGES THAT WERE MADE DURING THE COURSE OF CONSTRUCTION.


RPEQ 13231 DATE 16/04/21

TOWNSVILLE EARTHMOVING DO HEREBY CERTIFY THAT THE WORKS SHOWN ON THE 'AS CONSTRUCTED' DRAWINGS HAVE BEEN CONSTRUCTED IN ACCORDANCE WITH THE DRAWINGS AND CONTRACT DOCUMENTS APPROVED BY COUNCIL FOR THE CONSTRUCTION OF THE

AUTHORISED DELEGATE . DATE .1.5/04/21

MAIDMENT LAND PTY LTD Project: HOGARTH DRIVE EXTENSION - PART B HOGARTH DRIVE - HERVEY RANGE ROAD Q2 STORMWATER LONGITUDINAL SECTION Local Authority: Townsville City Council Locality: Bohle Plains

Sheet 1 of 1 Scale: AS SHOWN 40540/200 A Plan No:

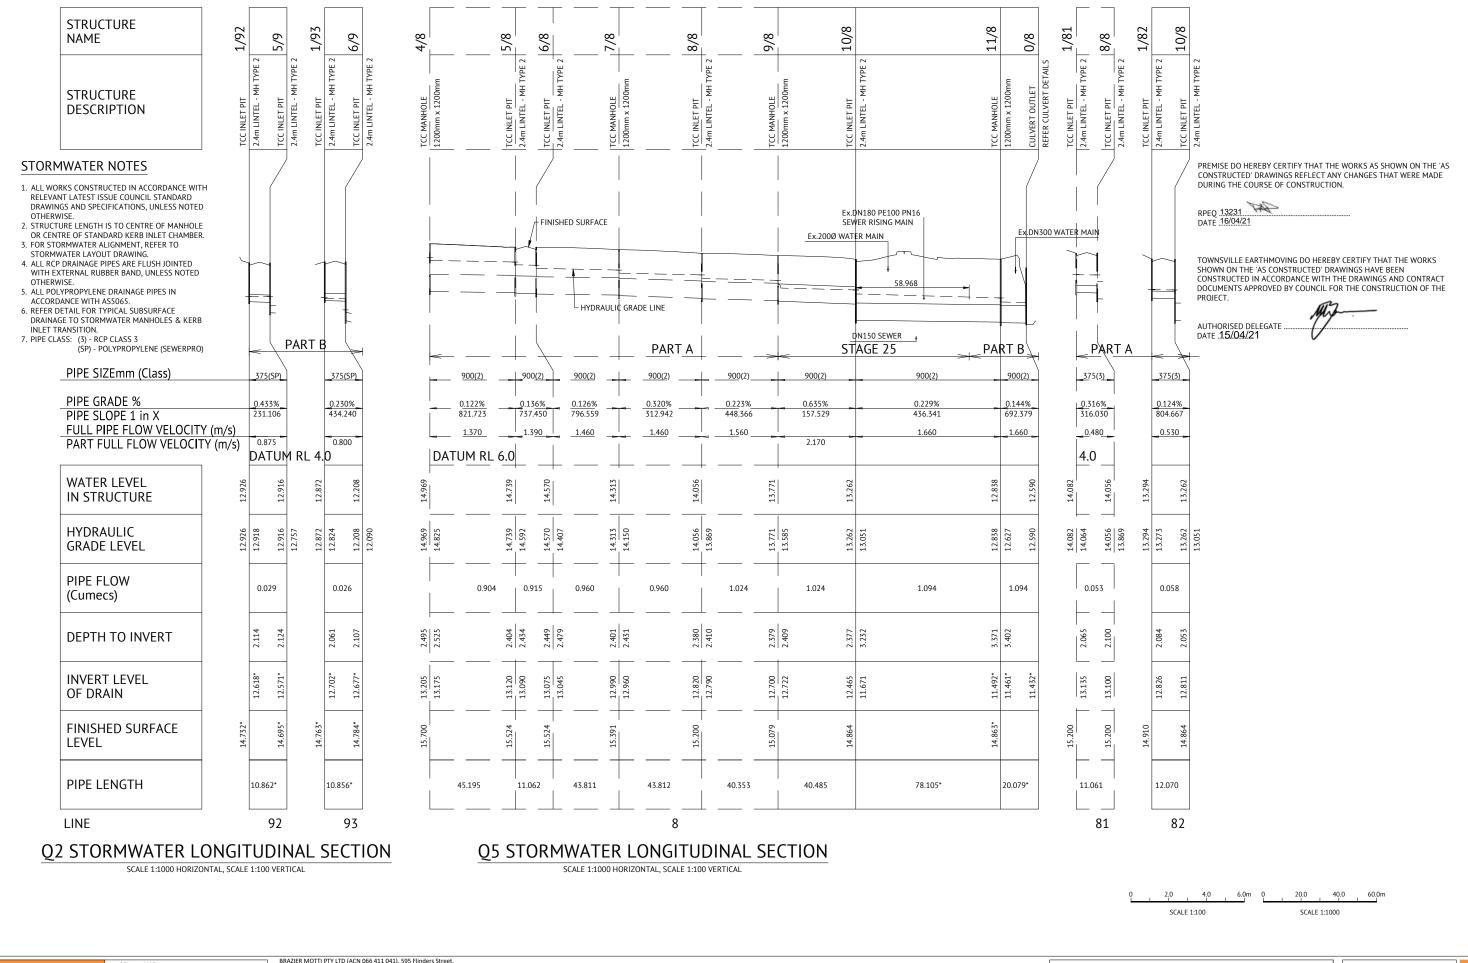

Job No: 40450-098-01 File No: 40540_201A.dw Document Set ID: 26063023 Version: 1, Version Date: 10/09/2024

B.M. Used: PSM200738 RL:13.973

oordinate Datum: Arbitrary

Meridian: MGA94 (Zone 55)

Coordinate Projection: Plane Rectangula

Surveyed by: BM

Townsville hereby certify that this Drawing accurately and correctly describes and records the nature and location of the works depicted by asterisks. Thereby they have been constructed for subdivision.


MAIDMENT LAND PTY LTD Client: **HOGARTH DRIVE EXTENSION - PART B** HOGARTH DRIVE - HERVEY RANGE ROAD Q2 AND Q5 STORMWATER LONGITUDINAL SECTION


Locality: Bohle Plain

Local Authority: Townsville City Council

Sheet 1 of 1 Scale: AS SHOWN 40540/201 A Plan No:



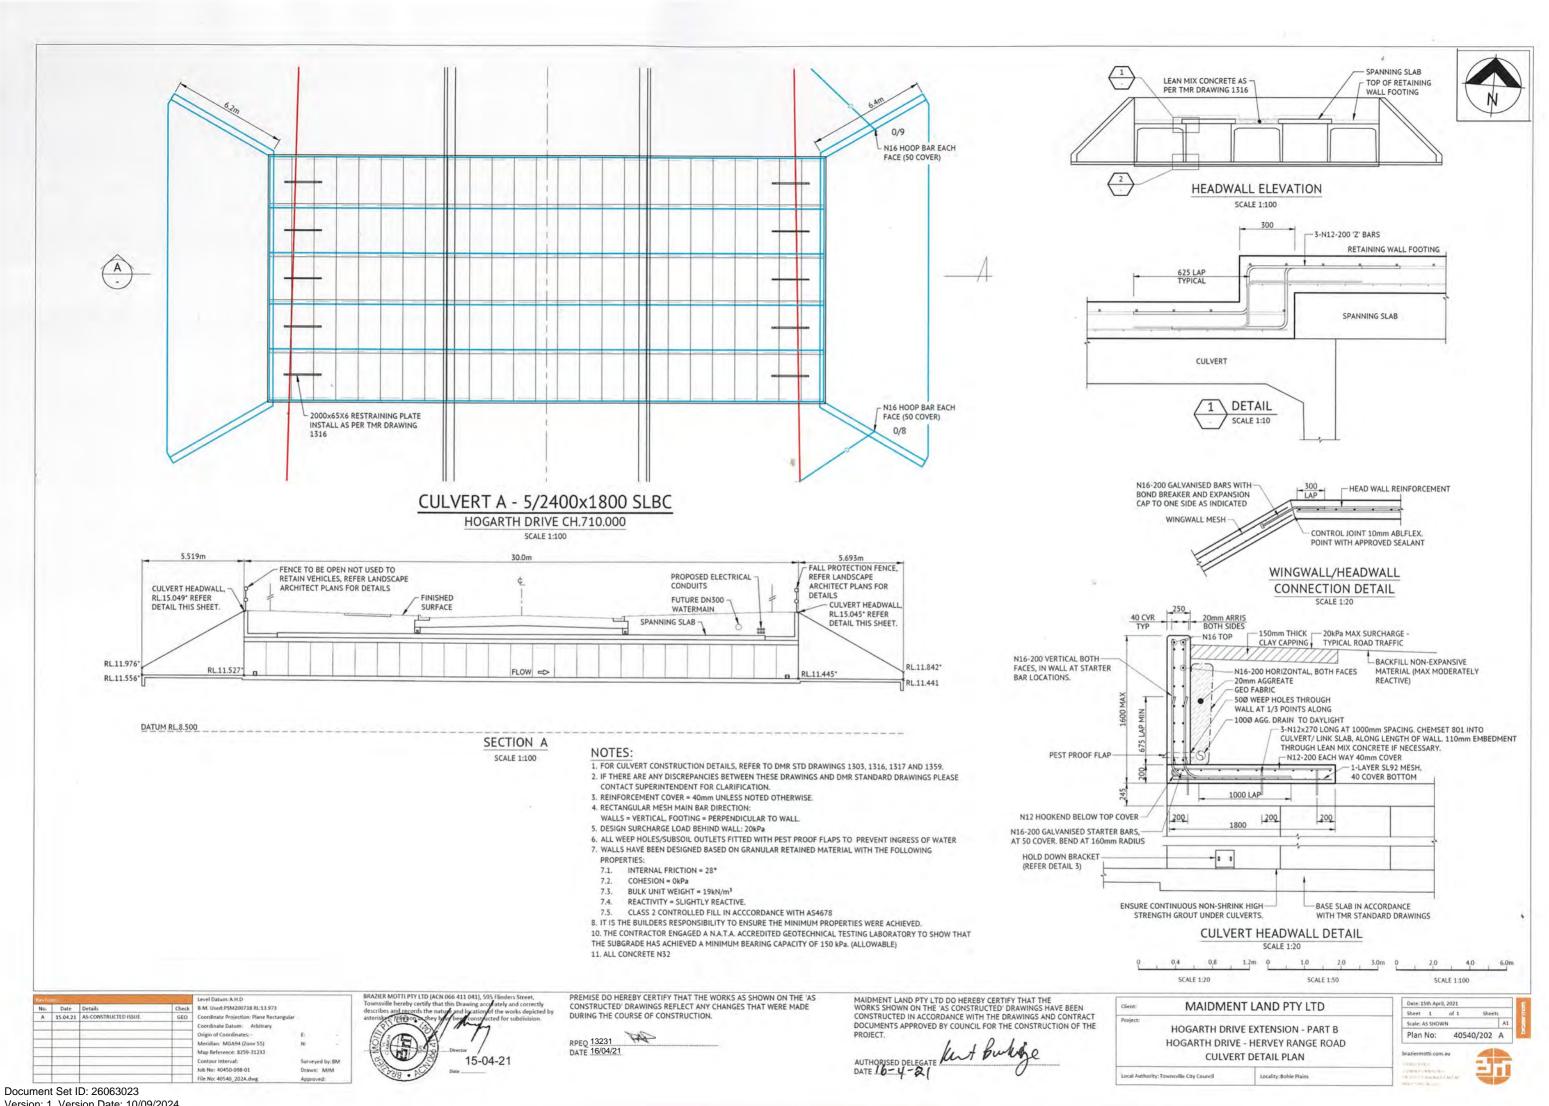

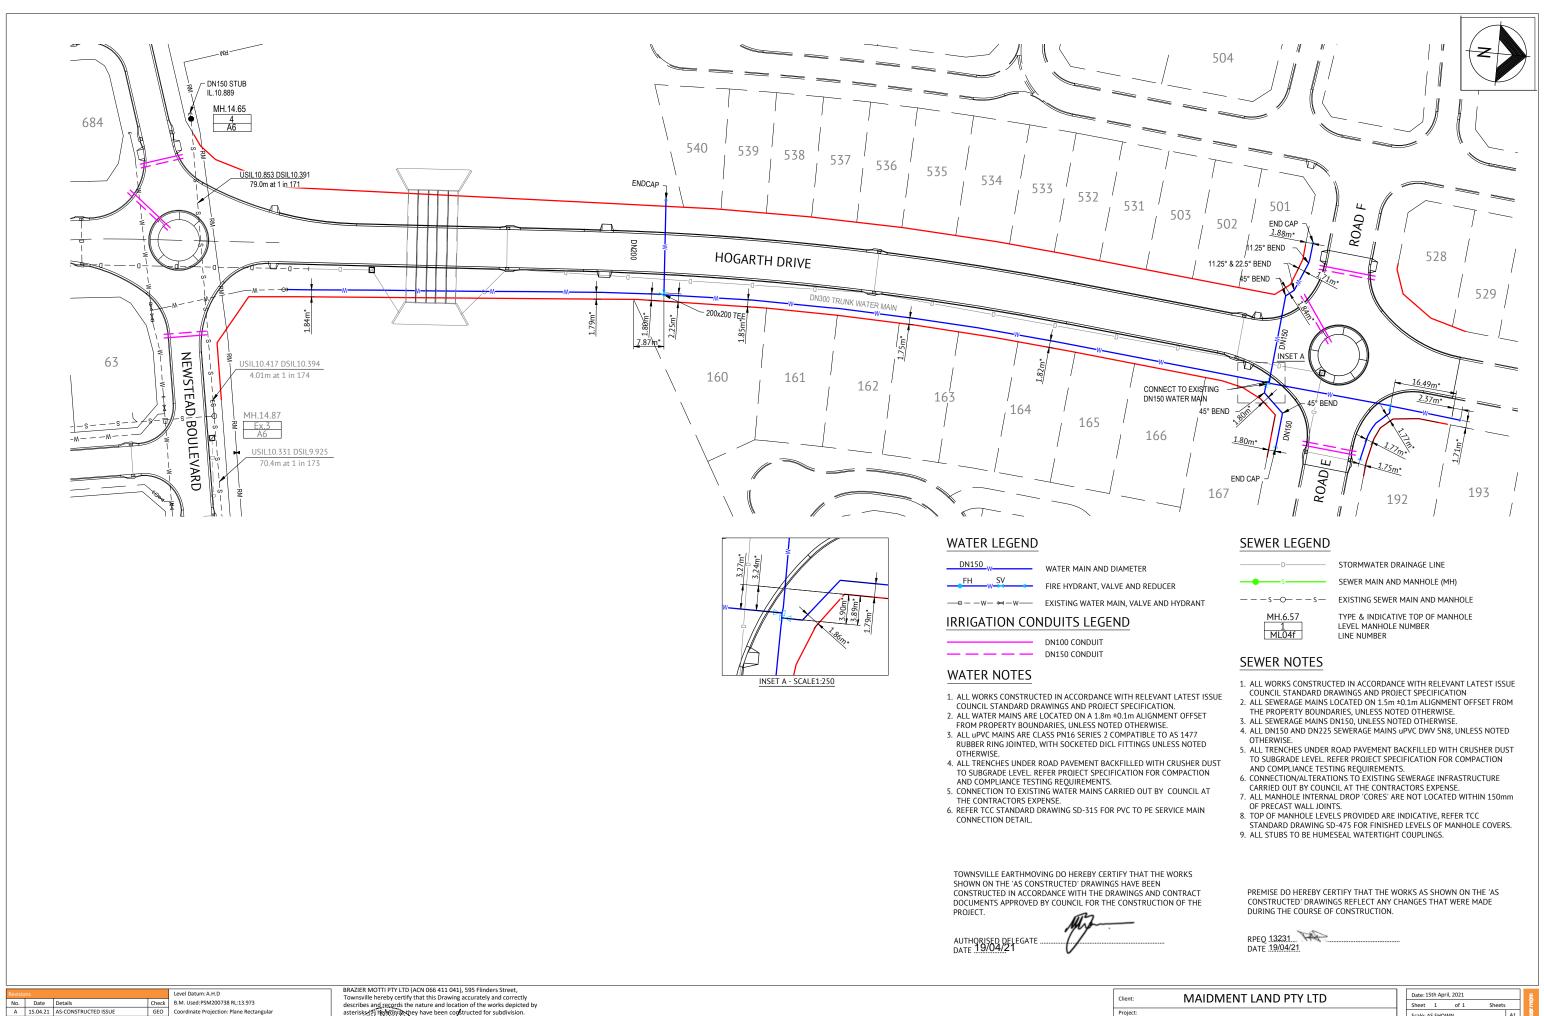

File No: 40540_203B.dwg Document Set ID: 26063023 Version: 1, Version Date: 10/09/2024

Coordinate Projection: Plane Rectangula

Drawn: MJM

Coordinate Datum: Arbitrary

Meridian: MGA94 (Zone 55)

Contour Interval

Job No: 40450-098-01

they have been constructed for subdivision

20.0 SCALE 1:500

Project: HOGARTH DRIVE EXTENSION - PART B HOGARTH DRIVE - HERVEY RANGE ROAD WATER AND SEWERAGE RETICULATION PLAN

Locality: Bohle Plains

Local Authority: Townsville City Council

Sheet 1 of 1 Scale: AS SHOWN Plan No: 40540/203 B

